

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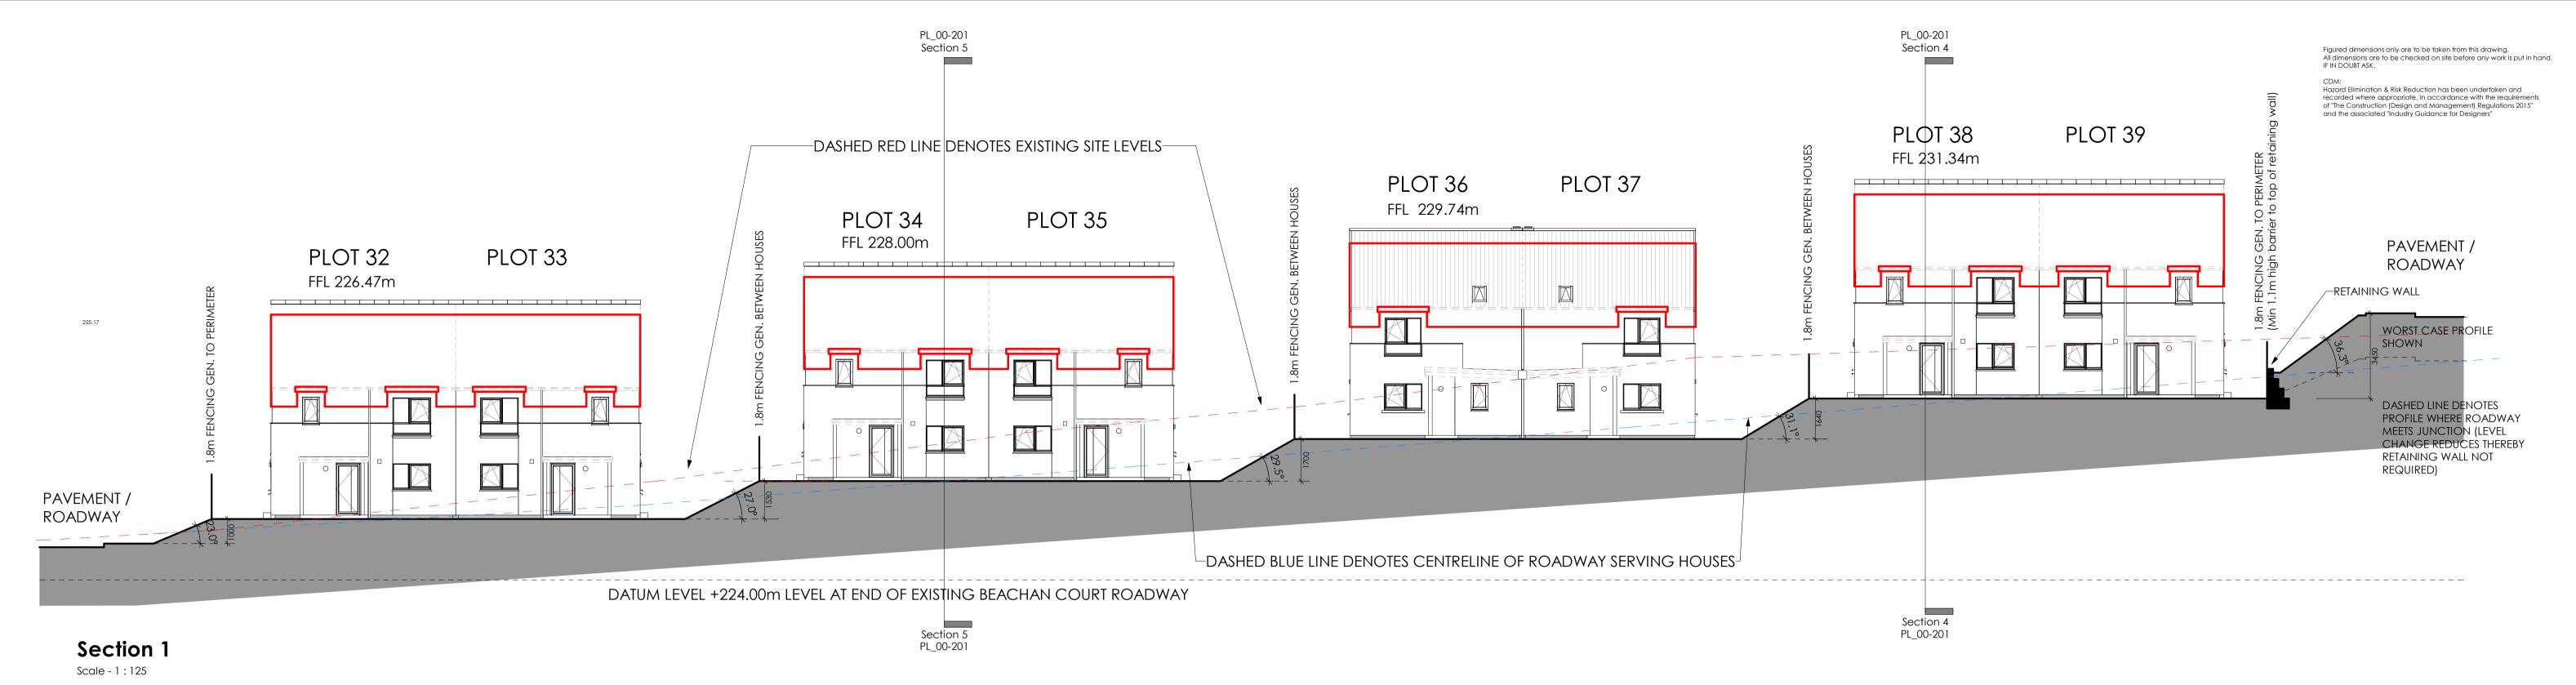
APPENDIX I

2017/0286/DET


PLANS

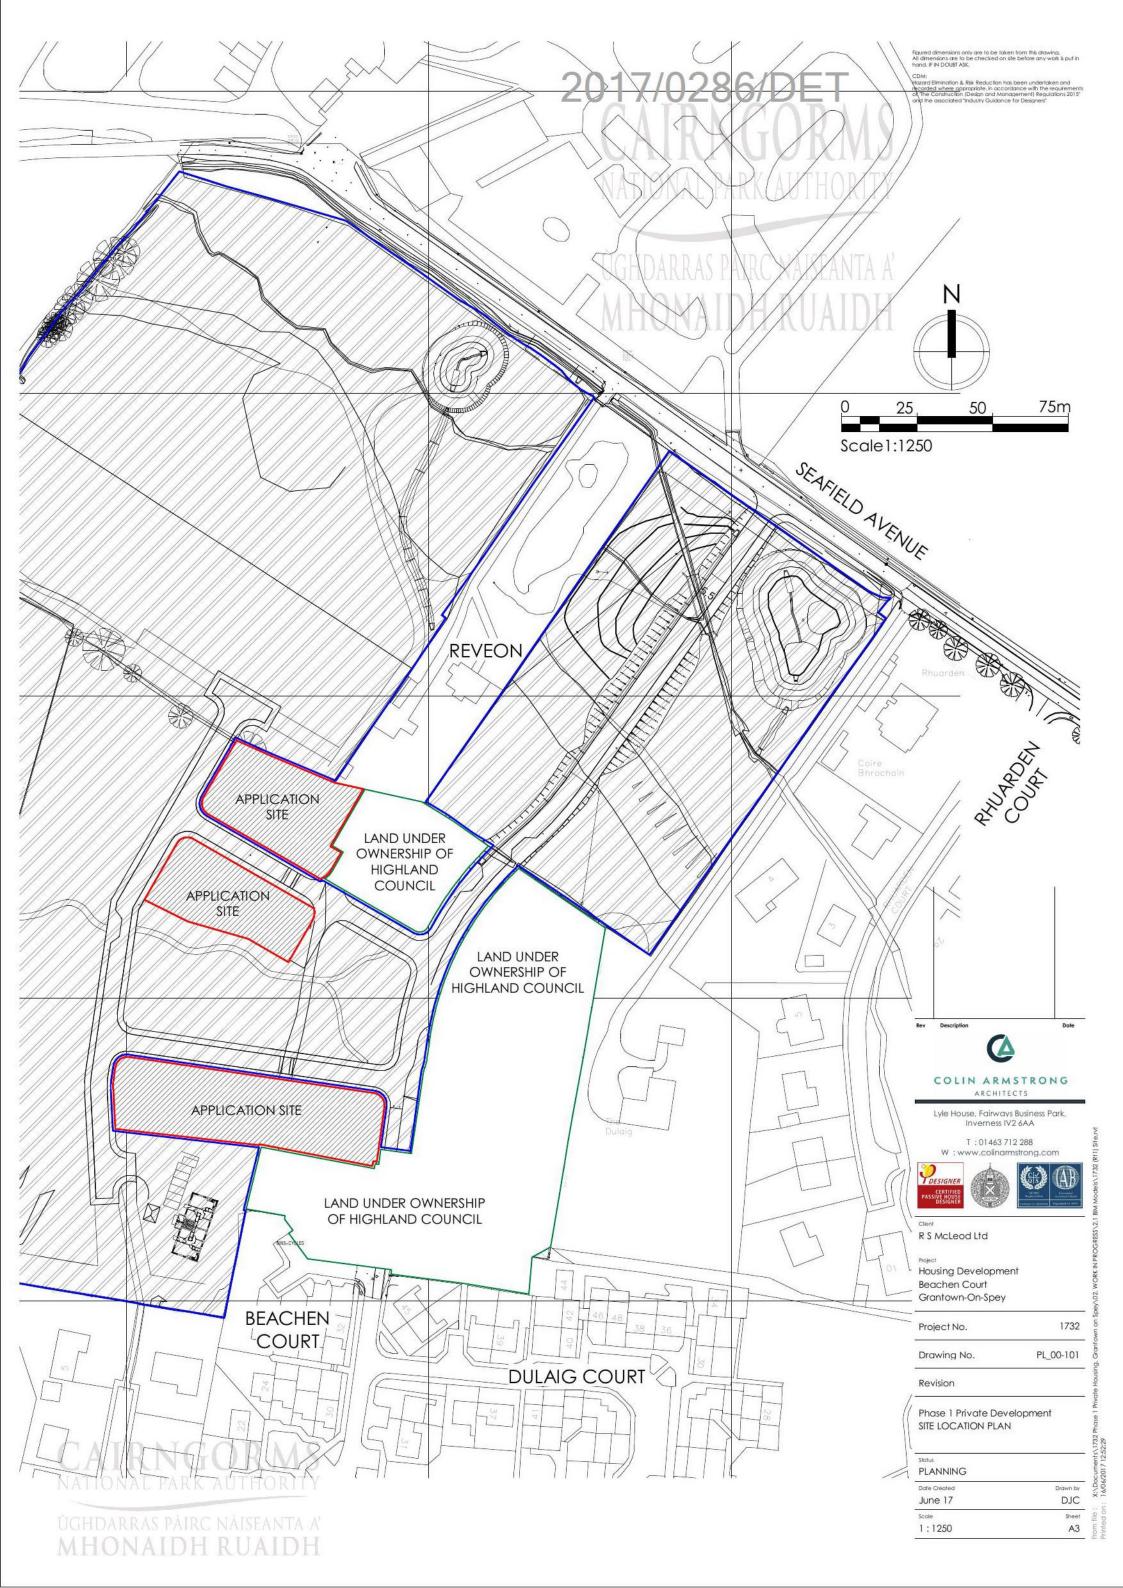

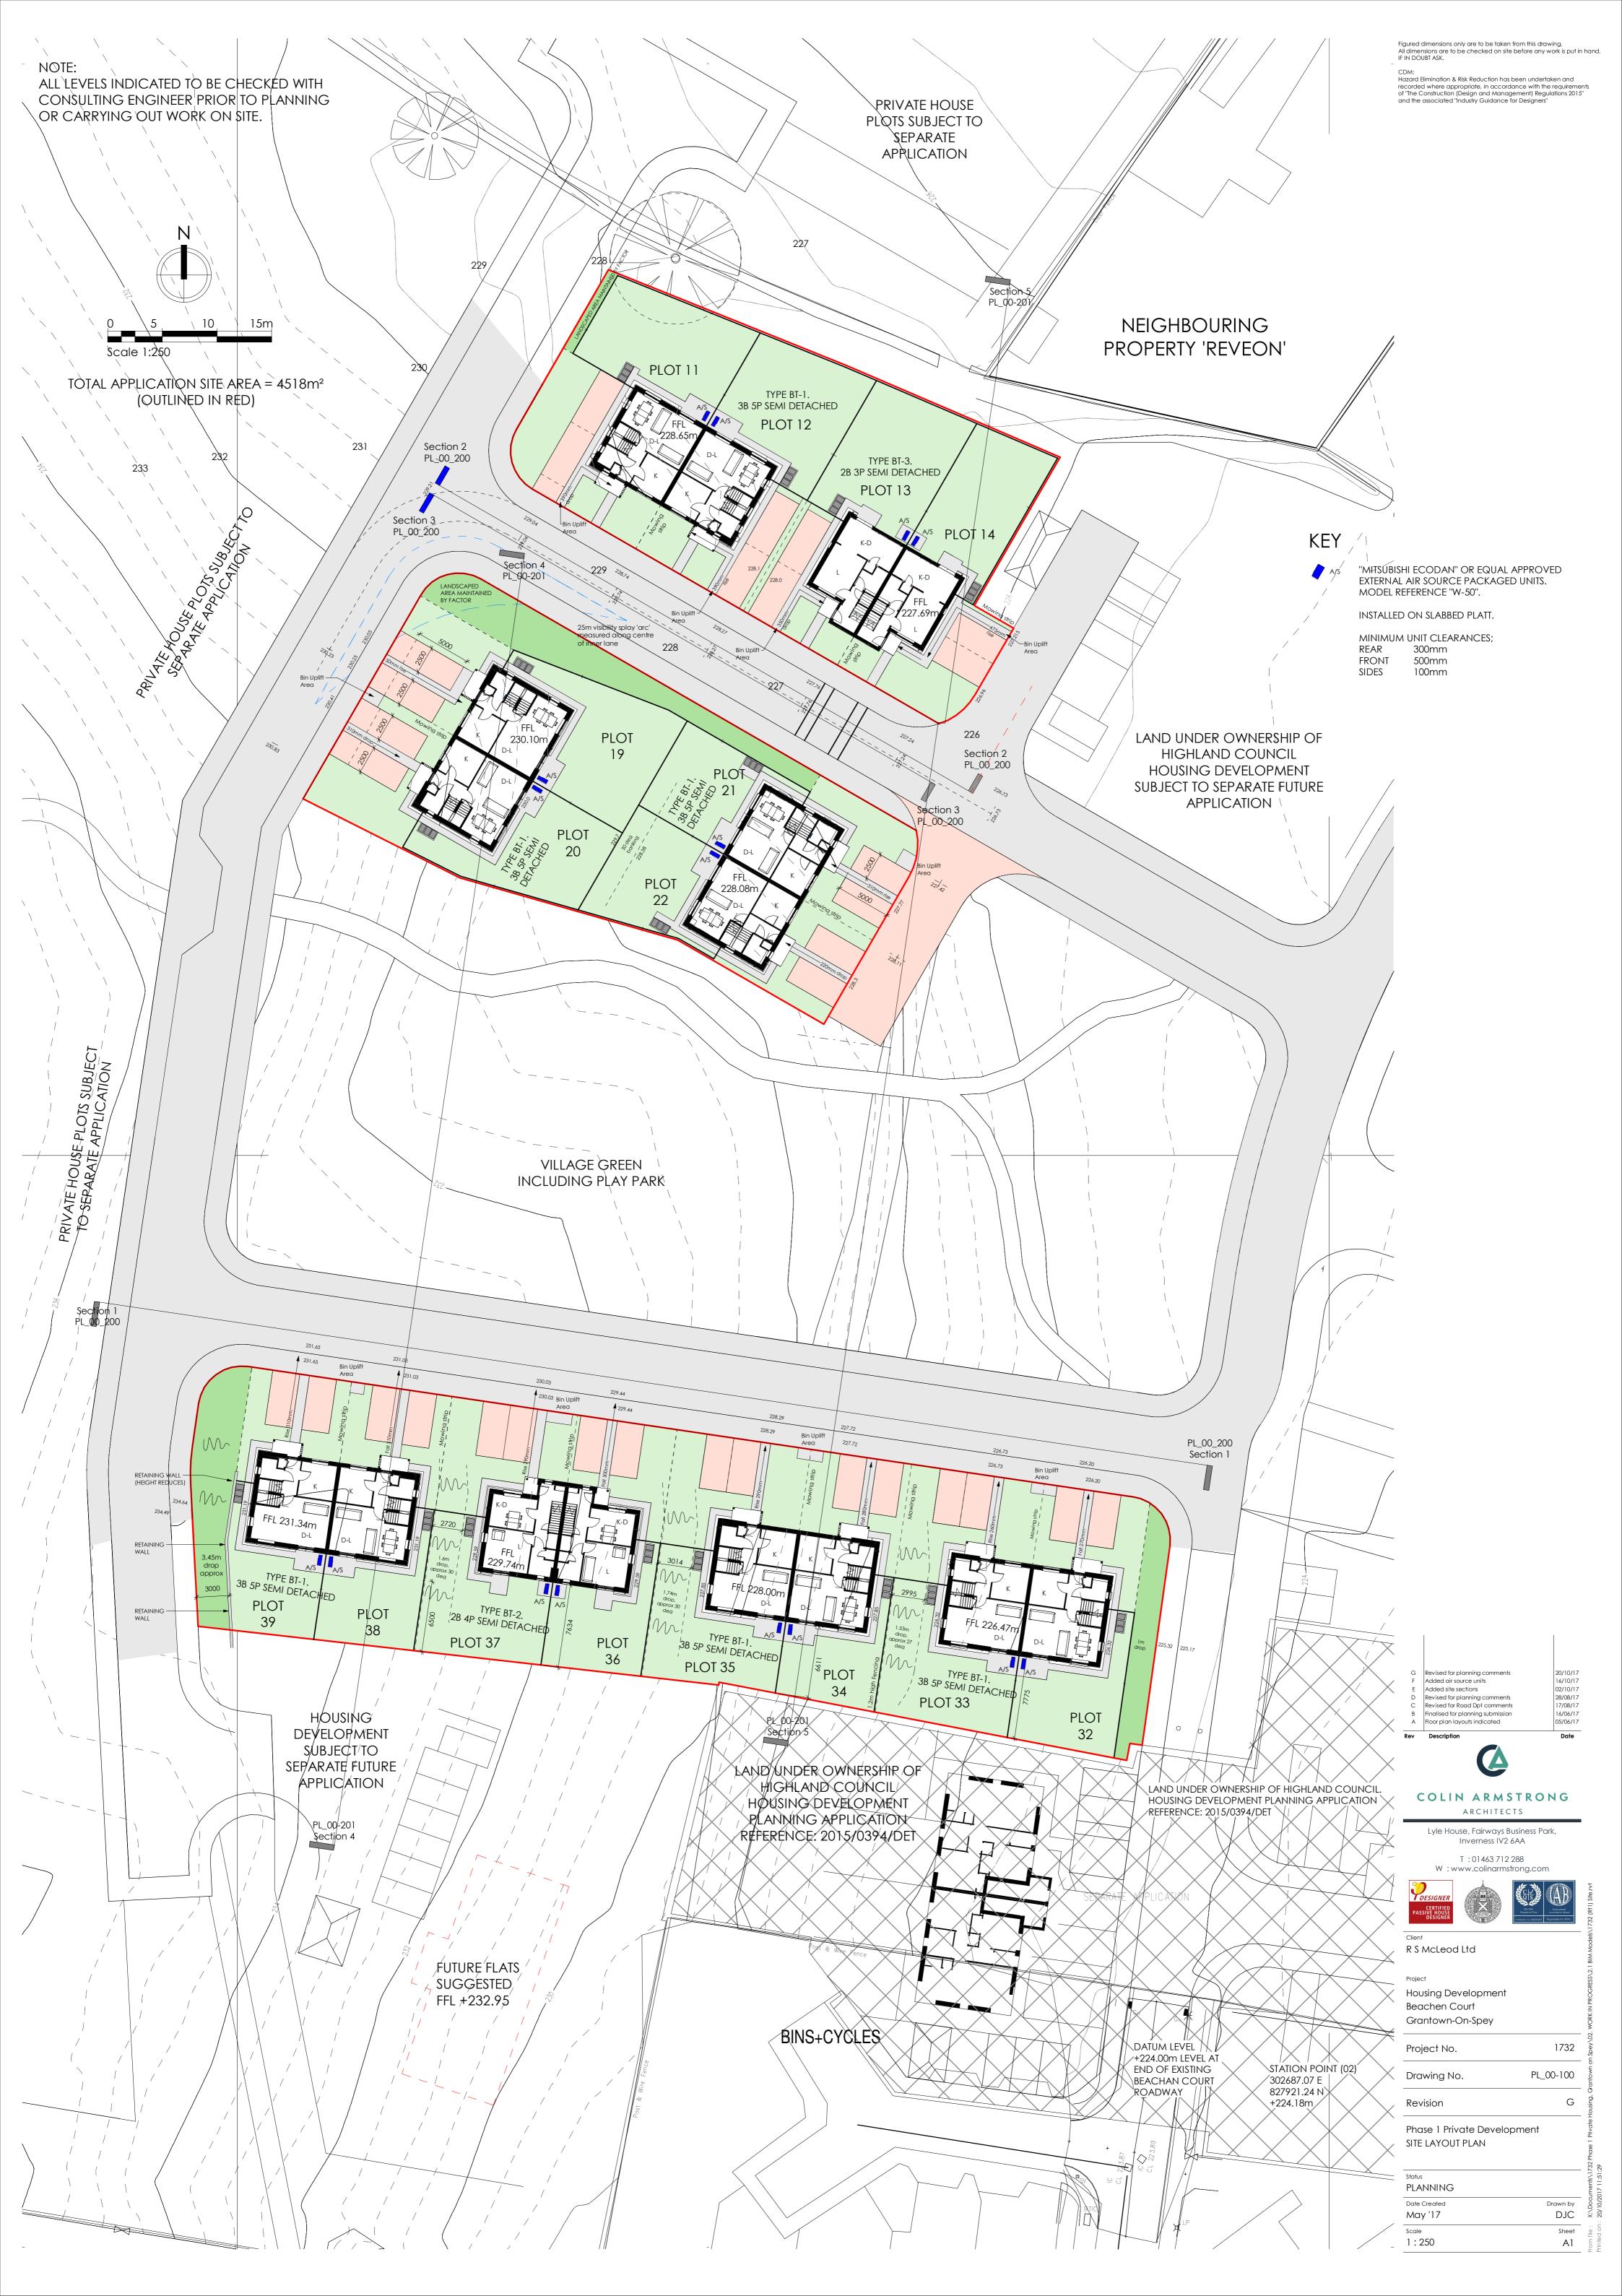




SECTION TAKEN THROUGH ROAD 1 of STRUCTURAL ENGINEER'S DRAWINGS

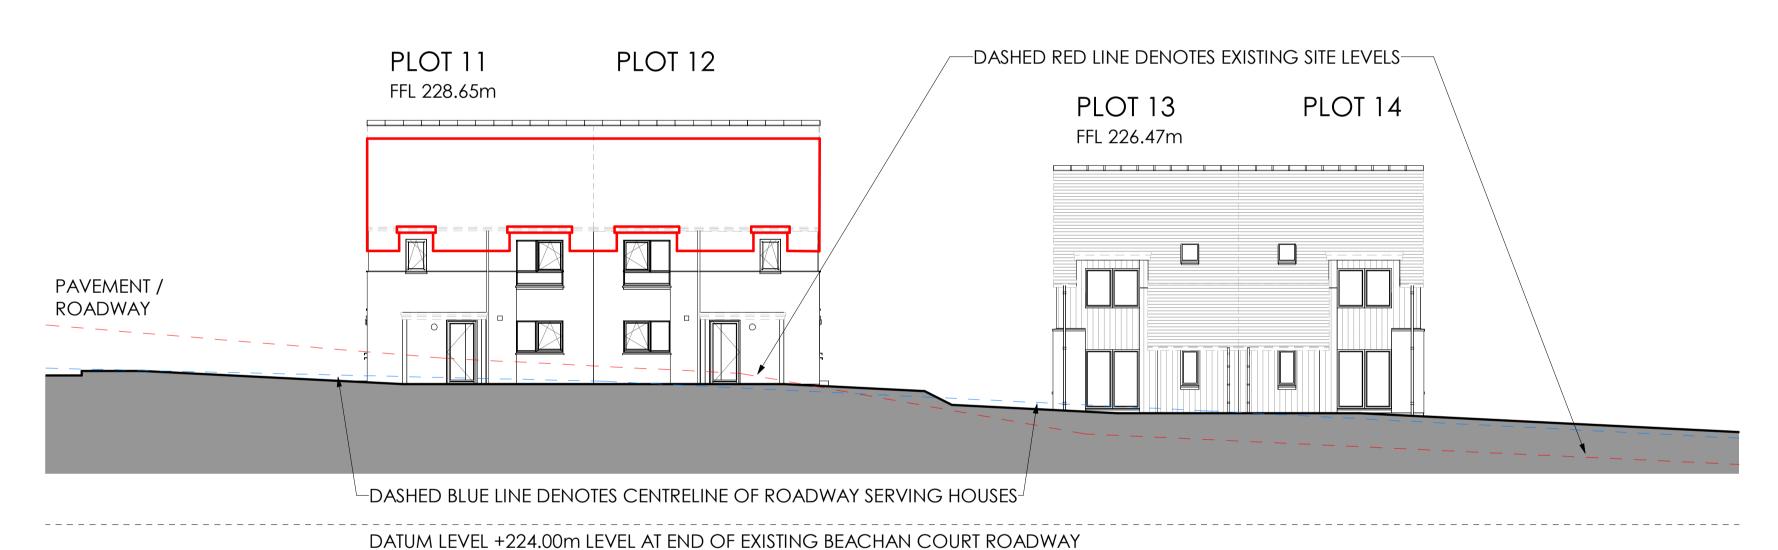

Section 2Scale - 1 : 125


SECTION TAKEN THROUGH ROAD 3 of STRUCTURAL ENGINEER'S DRAWINGS

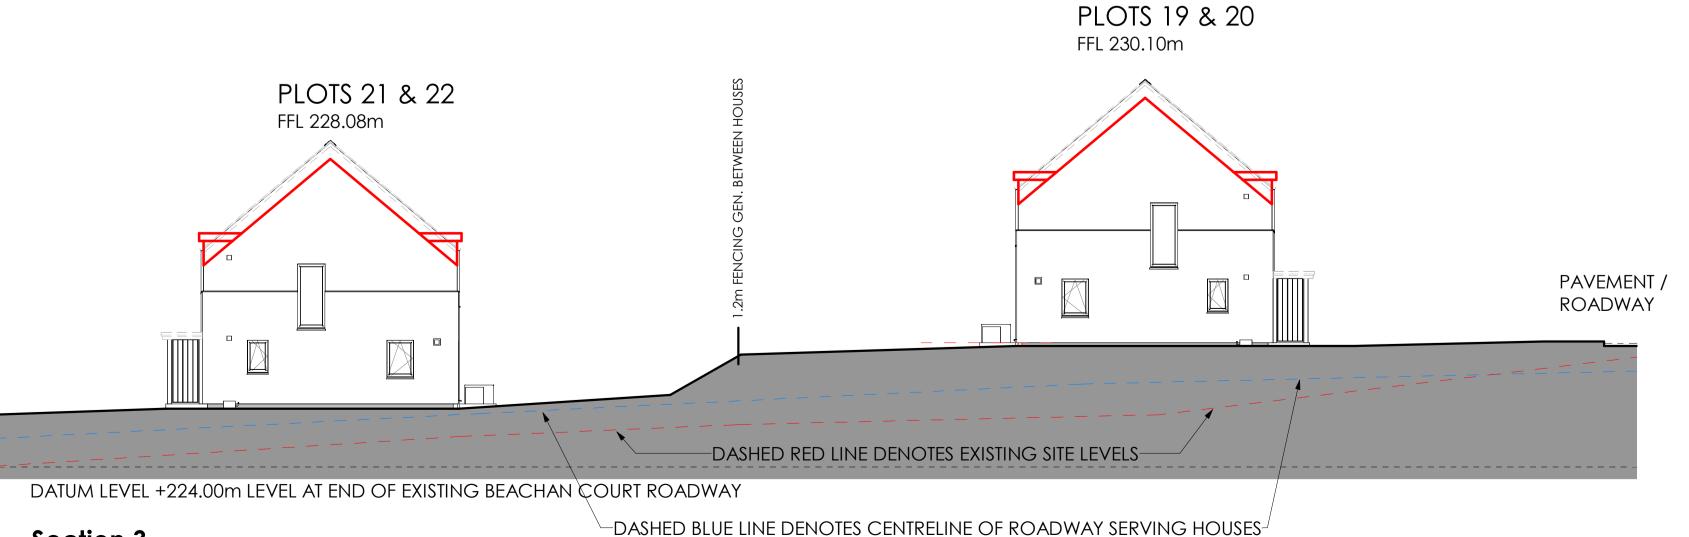

Section 3 Scale - 1:125

SECTION TAKEN THROUGH ROAD 3 of STRUCTURAL ENGINEER'S DRAWINGS



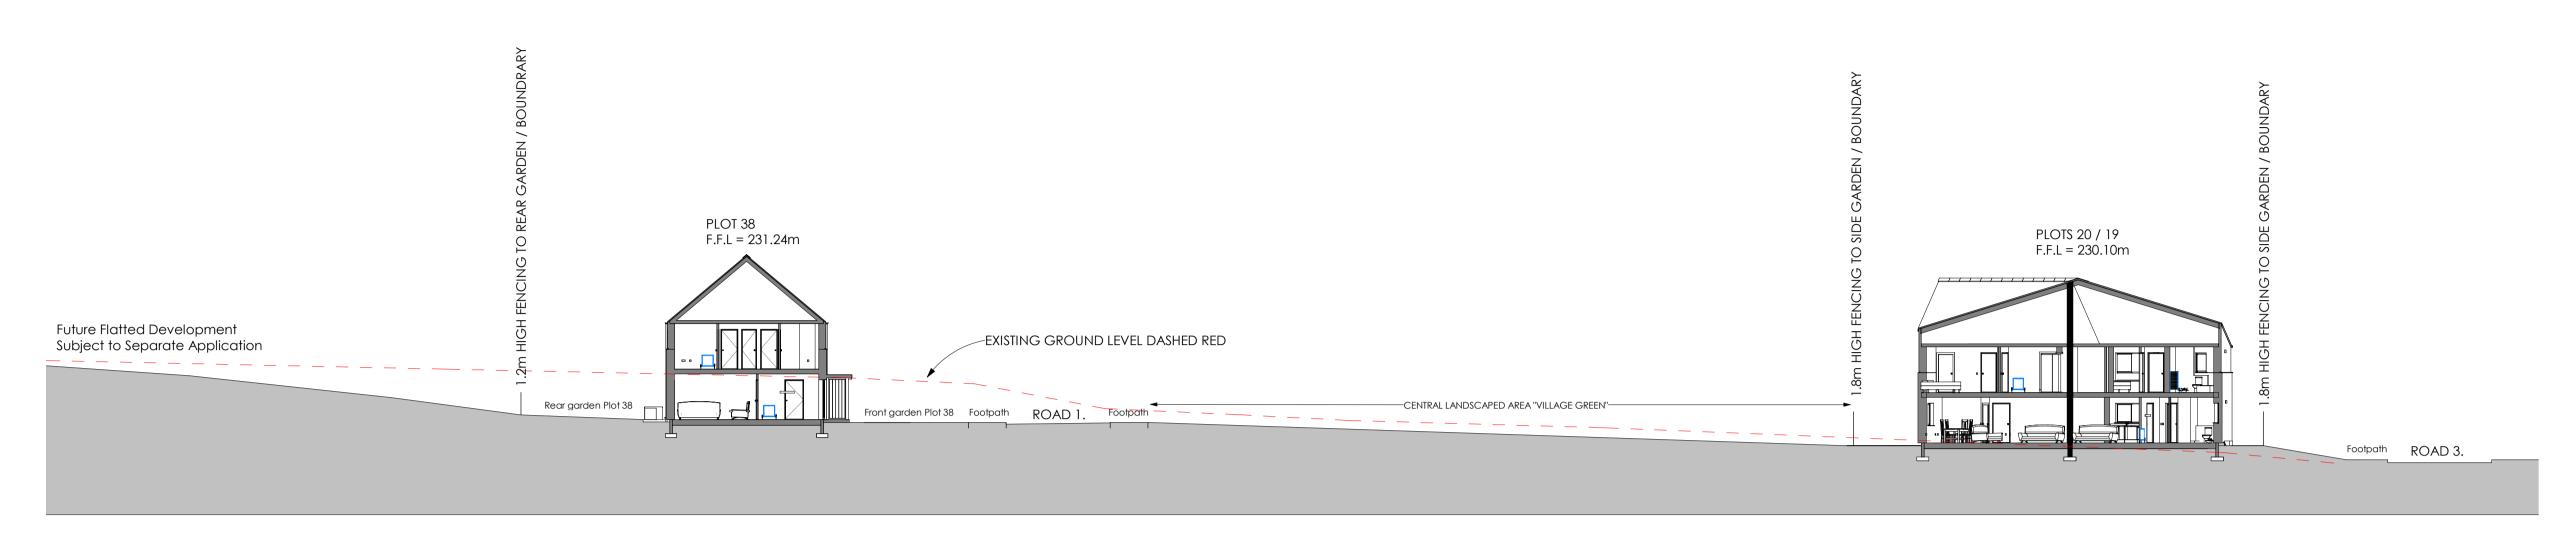

Section 4

DATUM LEVEL +224.00m LEVEL AT END OF EXISTING BEACHAN COURT ROADWAY

Scale - 1:200



Section 5Scale - 1 : 200

Figured dimensions only are to be taken from this drawing. All dimensions are to be checked on site before any work is put in hand. IF IN DOUBT ASK.

CDM:
Hazard Elimination & Risk Reduction has been undertaken and recorded where appropriate, in accordance with the requirements of "The Construction (Design and Management) Regulations 2015" and the associated "Industry Guidance for Designers"

B Revised for planning comments
A Revised to show ex. levels

Rev Description



ARCHITECTS

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1732

PL_00-201

Project
Housing Development
Beachen Court

Beachen Court
Grantown-On-Spey
Project No.

Drawing No.

Revision

SITE SECTIONS "VILLAGE GREEN"

atus


CDM:
Hazard Elimination & Risk Reduction has been undertaken and recorded where appropriate, in accordance with the requirements of "The Construction (Design and Management) Regulations 2015" and the associated "Industry Guidance for Designers"

2017/0286/DET

Entrance Elevation


Scale - 1:100



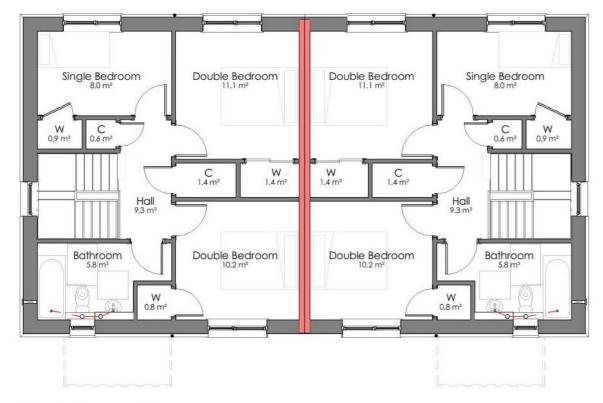

First Floor Plan

Scale - 1:100

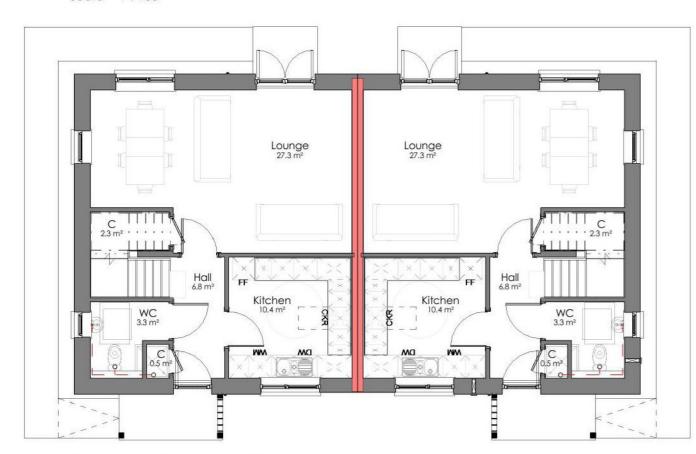

Ground Floor Plan

Scale - 1:100




Back Elevation

Scale - 1:100



Right Elevation

Scale - 1:100

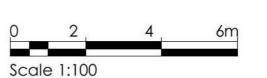



Cross Section

Scale - 1:100



COLIN ARMSTRONG

ARCHITECTS Lyle House, Fairways Business Park,

Inverness IV2 6AA T:01463712288







R S McLeod Ltd

Housing Development at Beachen Court Grantown-On-Spey

1185 Project No. BT1_00_100 Drawing No.

Revision

General Arrangement

Date Created	Drawn by	
May '17	DJC	
Scale	Sheet	
1:100	A2	

CDM:
Hazard Elimination & Risk Reduction has been undertaken and recorded where appropriate, in accordance with the requirements of "The Construction (Design and Management) Regulations 2015" and the associated "Industry Guidance for Designers"




Entrance Elevation

Scale - 1:100




Back Elevation

Scale - 1:100

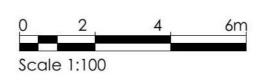


Side Elevation

Scale - 1:100

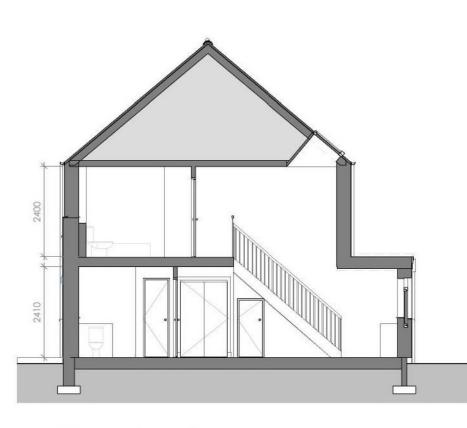

Cross Section

Scale - 1:100

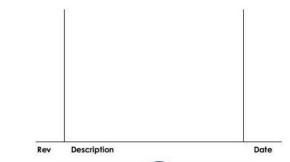



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R S McLeod Ltd.

Housing Development at Beachen Court Grantown-On-Spey

1732 Project No. BT2_00_100 Drawing No.

Revision

General Arrangement (2B 4P Semi)

Date Created	Drawn by
May '17	DJC
Scale	Sheet
1:100	A2

Double Bedroom

Double Bedroom 10.6 m²

Lounge 15.4 m²

Kitchen/Dining

Ground Floor Plan

Scale - 1:100

Double Bedroom

Double Bedroom 10.6 m²

Scale - 1:100

First Floor Plan

Lounge 15.4 m²

Kitchen/Dining

CDM: Hazard Elimination & Risk Reduction has been undertaken and recorded where appropriate, in accordance with the requirements of "The Construction (Design and Management) Regulations 2015" and the associated "Industry Guidance for Designers"



Front elevation

Scale - 1:100



Rear elevation

Scale - 1:100



Scale - 1:100



Cross Section

2017/0286/DET

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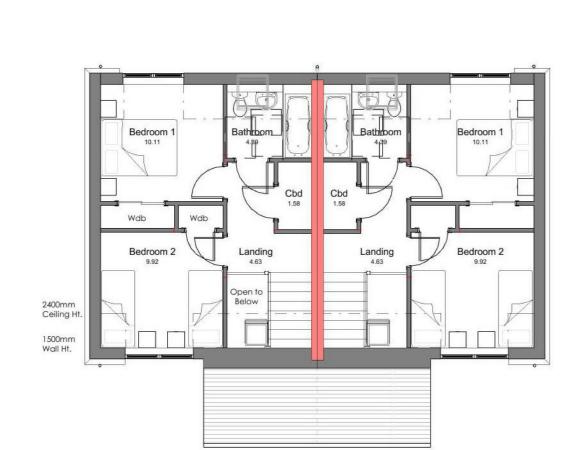
Housing Development at Beachen Court Grantown-On-Spey


1732 Project No. BT3_00_100 Drawing No.

Revision

General Arrnagement 2B3P Semi-Detached Houses

PLANNING Date Created Drawn by NG May '17 Sheet Low file ... Scale 1:100



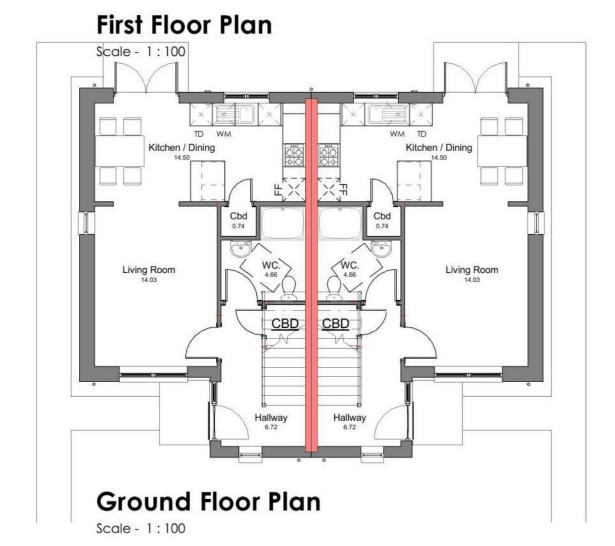

LH side

Scale - 1:100





Proposed grass seeded area maintained as close mown grass

Proposed tree planting in wildflower / grass seeded area maintained as long grass

Proposed tree planting in wildflower / grass seeded area maintained as long grass

Proposed tree planting in wildflower / grass seeded area maintained as long grass

Proposed footpath with tree planting

Existing ground line

Existing ground line

Existing pround line

SECTION THROUGH OPEN SPACE AREA - SECTION 5: 1:200

HLD - PHASE 1 (PRIVATE) HOUSING DEVELOPMENT, R S MCLEOD LTD, SEAFIELD ROAD, GRANTOWN ON SPEY- PLANTING SCHEDULE REV C 17.10.17 Trees

Species	Height	Girth	Pot Size	Specification	Density Number
Sorbus aucuparia	200-250cm		bare-root	Feather :5 brks :2x	Counted 21 No.
Betula pendula	200-250cm		bare-root	Feather:5 brks:2x	Counted 30 No.
Quercus robur	200-250cm		bare-root	Feather:5 brks:2x	Counted 8 No.
Populus tremula	200-250cm		bare-root	Feather:5 brks:2x	Counted 4 No.
Sorbus aucuparia 'Aspleniifolia'	300-350cm	10-12cm	rootballed	Selected Standard: 8 brks: 2x	Counted 4 No.
Prunus padus	300-350cm	10-12cm	rootballed	Selected Standard :4 brks: 2x	Counted 2 No.
Betula pendula	250-300cm	8-10cm	rootballed	Standard :6 brks: 2x	Counted 5 No.
Sorbus aucuparia	300-350cm	10-12cm	rootballed	Selected Standard :4 brks: 2x	Counted 7 No.

| Species | Height | Girth | Pot Size | Specification | Density | Number | Fagus sylvatica | 80-100cm | bare-root | Transplant :1+2 :4 brks | 5/m | 685 No.

Conifers Heigh

SpeciesHeightPot Size SpecificationDensityNumberPicea omorika125-150cm r'balledLeaders and laterals :4xCounted 3 No.Pinus sylvestris125-150cm r'balledLeaders and laterals :4xCounted 7 No.Pseudotsuga menziesii 40-60cm300ccCell grown transplantCounted 6 No.

NATIVE SHRUB THICKET

Proposed Phase 1 (Private) housing site boundaries.

Proposed 3-3.5m tall, selected standard tree planting-

Proposed 2-2.5m tall, feathered tree planting to open

Proposed 1.25-1.5m high feathered conifer trees, Pine

Proposed open spaces: top-soiled, cultivated and grass

Proposed 2-2.5m feathered trees: Rowan species.

Proposed front gardens: top-soiled, stone picked,

Proposed rear gardens: top-soiled, stone picked and

Proposed mixed species hedging to garden boundaries

Proposed Beech hedging to garden boundaries with open

spaces and at selected plot boundaries- maintained by

future residents at 0.9m high. Hedge at plot 19 within

Proposed native shrub thicket planting to slopes in open

space area. Shrub planting to be protected with mesh

shelters and areas between plants bark mulched.

with open spaces and at selected plot boundaries-

maintained by future residents at 0.9m high.

visibility splay to be maintained at 0.75m high.

Birch, Rowan and Alder species.

spaces - Birch species.

cultivated and turfed.

cultivated.

SpeciesHeightPot SizeMix Species ContributionSpecificationDensityNumberCalluna vulgaris15-20cm9cm25%Bushy2/m²31 No.Corylus avellana40-60cm200cc20%Cell grown transplant2/m²25 No.Juniperus communis ssp 'Communis'10-20cm200cc35%Cell grown transplant2/m²43 No.Vaccinium myrtillus20-40cm200cc20%Cell grown transplant2/m²25 No.

REVISIONS

A: 01.09.17 Landscape proposals updated with planting details, planting schedule and a maintenance regime prepared for the planning issue.KW
B: 10.10.17 Landscape proposals revised to include landscape treatment* to central open space (Village Green). Drawing upscaled to Ao format. (* Landscape proposals extracted from Roads and Strategic landscape proposals drawing.) Landscape cross sections 4 and 5 added to drawing for information.KW
C: 18.10.17 Landscape proposals updated with amended proposed contours from Arch Henderson and existing ground lines added to sections 4 and 5.KW

SECTION THROUGH OPEN SPACE AREA - SECTION 4: 1:200

PLANTING MIXED SPECIES HEDGING
The proposed mixed species hedging comprising

The proposed mixed species hedging comprising 55% Beech, 15% Hazel and 30% Holly will be planted in random grouping of plants of each species, minimum of 5-7 plants per grouping- hedging to be planted at 5/m density. All hedging plants to be protected with clear spiral guards- Rainbow 45cm x 38mm diameter supplied with a 10-12cm diameter bamboo canes.

NATIVE SHRUB THICKET PLANTING

The proposed native species shrub thicket planting comprising Heather, Hazel, Juniper and Blaeberry are to be planted in groupings of minimum 5-7 plants per grouping at a rate of 2/m2. Thicket planting to be protected with Green-tech 60 x 30cm diameter green mesh shelters and secured with 2 no. ratchet ties to 32 x 32mm square softwood posts.

Feathered trees to be protected with green mesh shelters 1.2m high x 18cm (12mm square grid size) attached to 50mm diameter machine rounded stakes and Holdfast belts and rubber blocks. (Feathered trees - HB1 blocks with HP25 PVC Belting.)

Conifer species planting to have a single 50mm machine rounded stake attached to the lower stem at 45 degrees, secured with a Holdfast HB1 Block and HP 25 PVC Belting Base of conifers to be protected with a 75 x 50mm clear spiral guard.

STANDARD TREE PLANTING
The proposed standard trees

The proposed standard trees are to be secured with 50mm machine rounded stakes set 500mm above ground level with Holdfast HP40 belting with HP2 rubber blocks. Birch trees to be secured with 50mm machine round stakes set at 1.2m high above ground with Holdfast HP40 belting with HP2 rubber blocks.

Base of trees to be protected with a Green Tech Premium Strimmer Guards: 335mm wide x 200mm high x 95mm diameter- 1 per tree.

For details of the proposed 5 year maintenance and management regime refer to separate HLD document.

LANDSCAPE NOTES

All areas to be soft landscaped to be litter picked and all site debris / stones etc to be removed from site. All subsoil to be thoroughly de-compacted to ensure that they are free draining.

Samples of proposed topsoil to be approved by Highland Landscape Design and subsoil areas to be topsoiled will be inspected by HLD prior to topsoil being spread.

Mixed hedging to be pit planted into 450 x 450 x 300mm deep hedging trench of premium quality topsoil mixed with PAS 100 SOIL IMPROVER (35mm layer over soil) laid on a clean de-compacted subsoil layer. Soil improver to be workd oin during planting works.

Selected standard and standard trees to be pit planted into 1000 x 1000 x 450mm deep pits with base broken up for a further 150mm. Pits to be backfilled with premium quality topsoil mixed with PAS 100 Soil improver (35mm deep over tree pit - worked in during planting.)

Small feathered trees pit planted as above in 600 x 600 x 300mm deep pits, with the base broken up for a further 150mm.

GRASSED AREAS
Close mown grass areas to be formed with 150mm deep premium quality topsoil laid on a clean de-compacted subsoil layer.
Grassed areas to be seeded using a Blec 2 pass technique using the following seed mix sown at 25g/m2:

Agrostis capillaris (Common Bent) 10%
Anthoxanthum oderatum (Sweet Vernal Grass) 20%
Deschampsia flexuosa (Wavy Hair Grass) 30%

Festuca ovina (Sheeps Fescue) 25% Poa pratensis (Smooth stalked Meadow Grass) 15%

NOTE: The landscape works shown for the 'Village Green' open space area will be undertaken at the end of the Phase 1 (Private)building works.

ALL DIMENSIONS TO BE CHECKED ON SITE
WORK TO FIGURED DIMENSIONS ONLY
REPORT DISCREPANCIES TO THE LANDSCAPE ARCHITECT
AT ONCE BEFORE PROCEEDING



FORRES, MORAYSHIRE, SCOTLAND, IV 36 1AN. TEL: 01309 692005 jim@highlandlandscapedesign.co.uk

MORVEN, CAROLINE STREET,

ent

R S McLeod Ltd

PLANNING

KEITH L WOOD BA (HONS) CMLI LANDSCAPE ARCHITECT

1, Old Branziet Cottage, Balmore, By Torrance, Glasgow, G64 4AH. Tel: 01360 620358 Mob:07584 054586 email: keith.l.wood@btopenworld.com

oject Title

PHASE 1 (PRIVATE) HOUSING DEVELOPMENT, BEACHAN COURT, GRANTOWN ON SPEY. Drawing Title SOFT LANDSCAPE PROPOSALS PLANTING PLAN

Scale 1:200@Ao Date 01.09.17

Drawn k wood Approved J Legge

Drawing No. Rev.

HLD K298.17/SL-01

