AGENDA ITEM 5

APPENDIX I

2017/0264/DET

PLANS



Scale : 1:2500

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HEALTH AND SAFETY NOTES SIGNIFICANT RESIDUAL HAZARDS PRESENT DESCRIPTION

Other (specify)

Health Hazards Structural Instability Ground Conditions 1 2 3 4 Buried and Overhead Services Underground Structures Adjacent Activities Site Restrictions

existing bridge.

1/ Existing soil contamination (previous use as yard for mill) Danger to residents recommendations of specialists
2/ Existing overhead power line and BT line and 2/ Divert existing overhead power line and rising main and main sewer Danger to operatives BT line before construction commences and 3/ Railway - noise pollution and hazard to occupants, conflict between operations on site and to rail traffic 4/ Access restricted road width and across

REVISIONS ACTIONS / NOTES: 1/ Contamination report carried out - follow

28.06.17 ensure buildings are safe distance from sewers 3/ Follow recommendations of acoustic report, safe fence to boundary, ensure no plant can oversail railway boundary and site is secure 4/ Ensure plant and deliveries are appropriate to site access, check existing bridge can support proposed delivery loads

DATE 6.06.17

Boundary adjusted Site boundary adjusted to match Engineer's drawings CLIENT **Atholl Estates** PROJECT

Housing at Watermill Estate

Blair Atholl PURPOSE

Planning

SCALE 1:2500 JOB NO. 13/12/2016 4734

DRAWN BY DATE

 KM

DRAWING TITLE

Location Plan


DWG. NO.

LOC1

PAPER SIZE Α3 REVISION b

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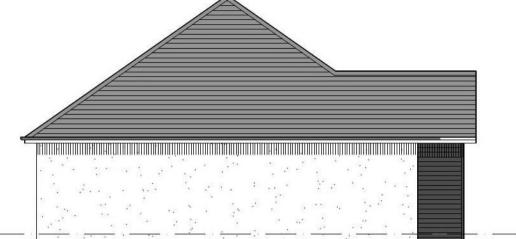


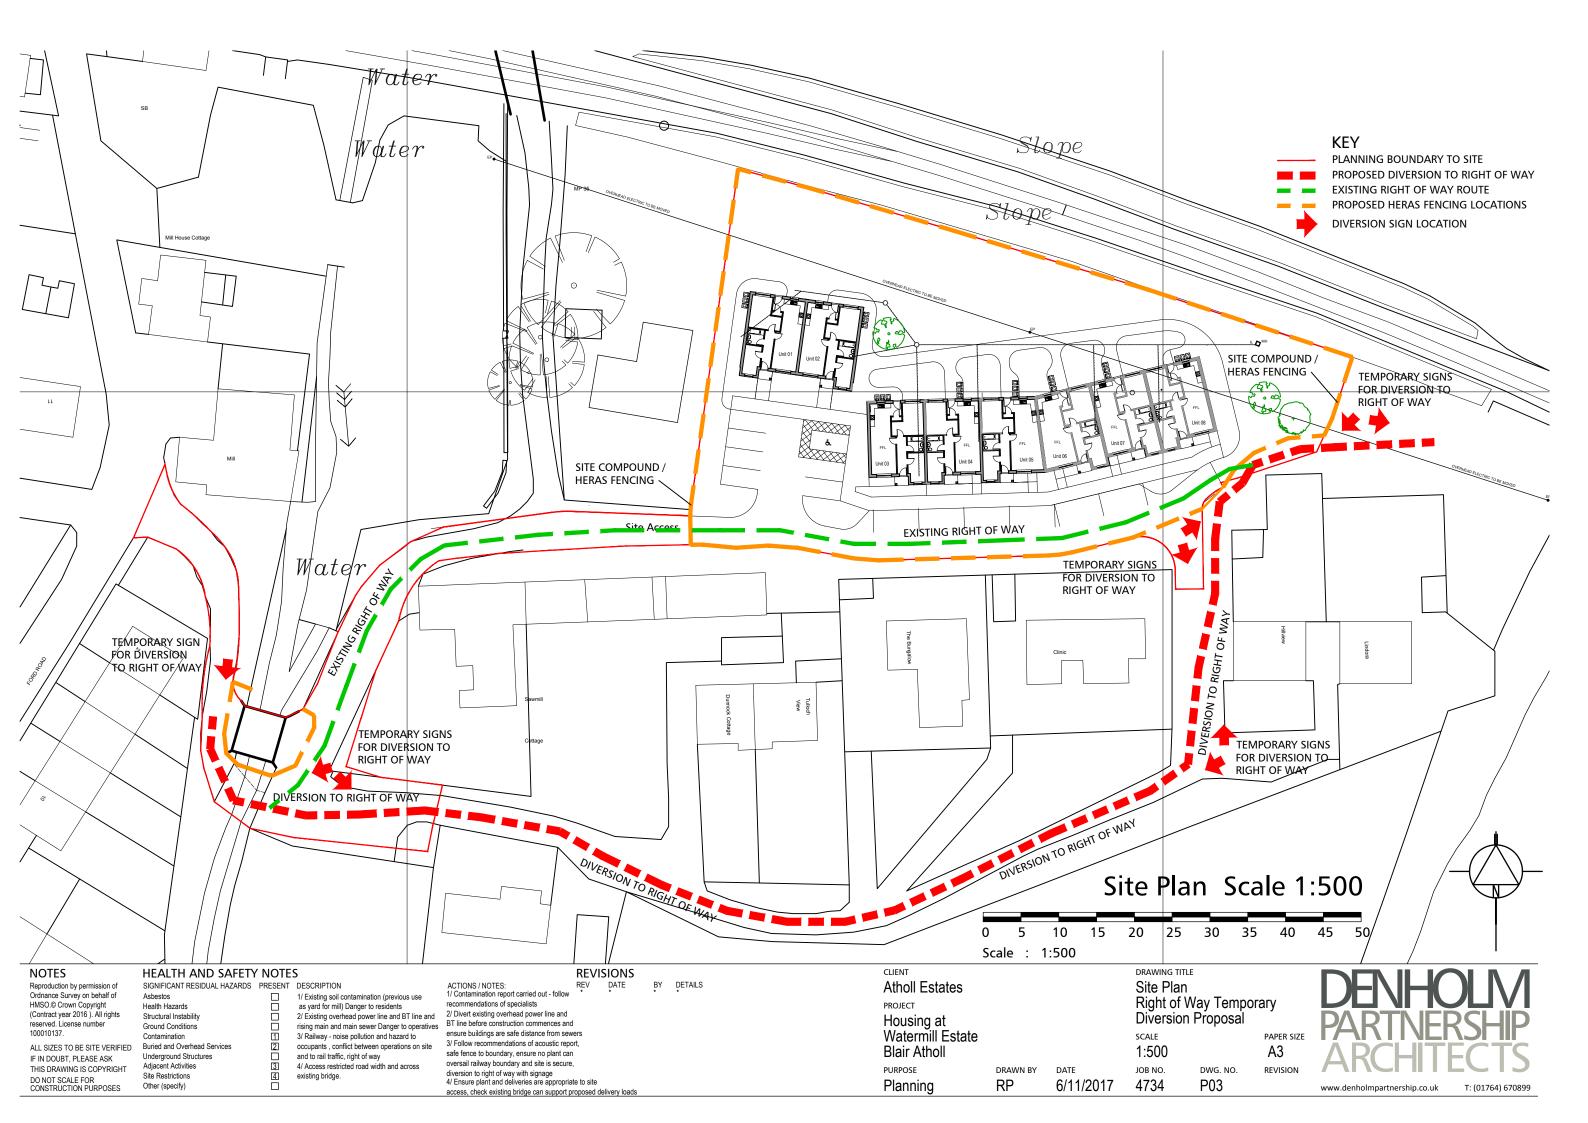

East Elevation Units 03-08



West Elevation Units 03-08




West Elevation Units 01-02

East Elevation Units 01-02




MATERIALS Roof - Natural slates colour grey. Rainwater goods - Black uPVC Walls - White roughcast render on blockwork in areas shown. Timber cladding in areas shown (colours to be agreed with PKC Planning Dept.)
150mm smooth render bands around all openings in roughcast walls.
Windows - White coloured high performance double glazed timber Doors - High performance timber painted

North Elevation Units 01-02

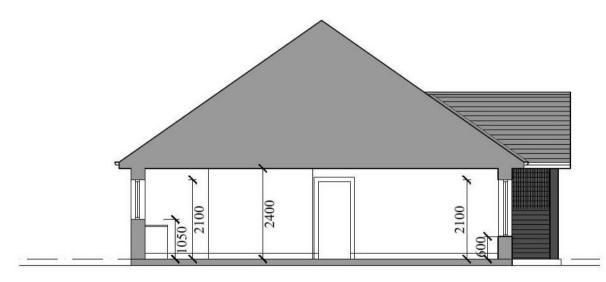


Section A-A

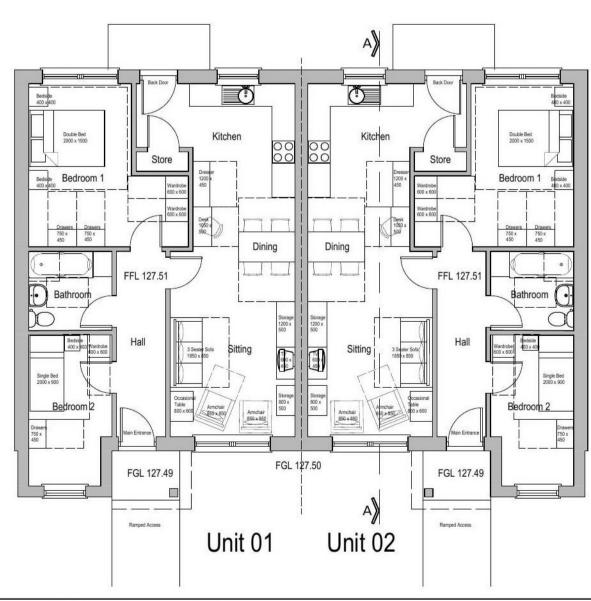

North Elevation Units 03-08



South Elevation Units 03-08

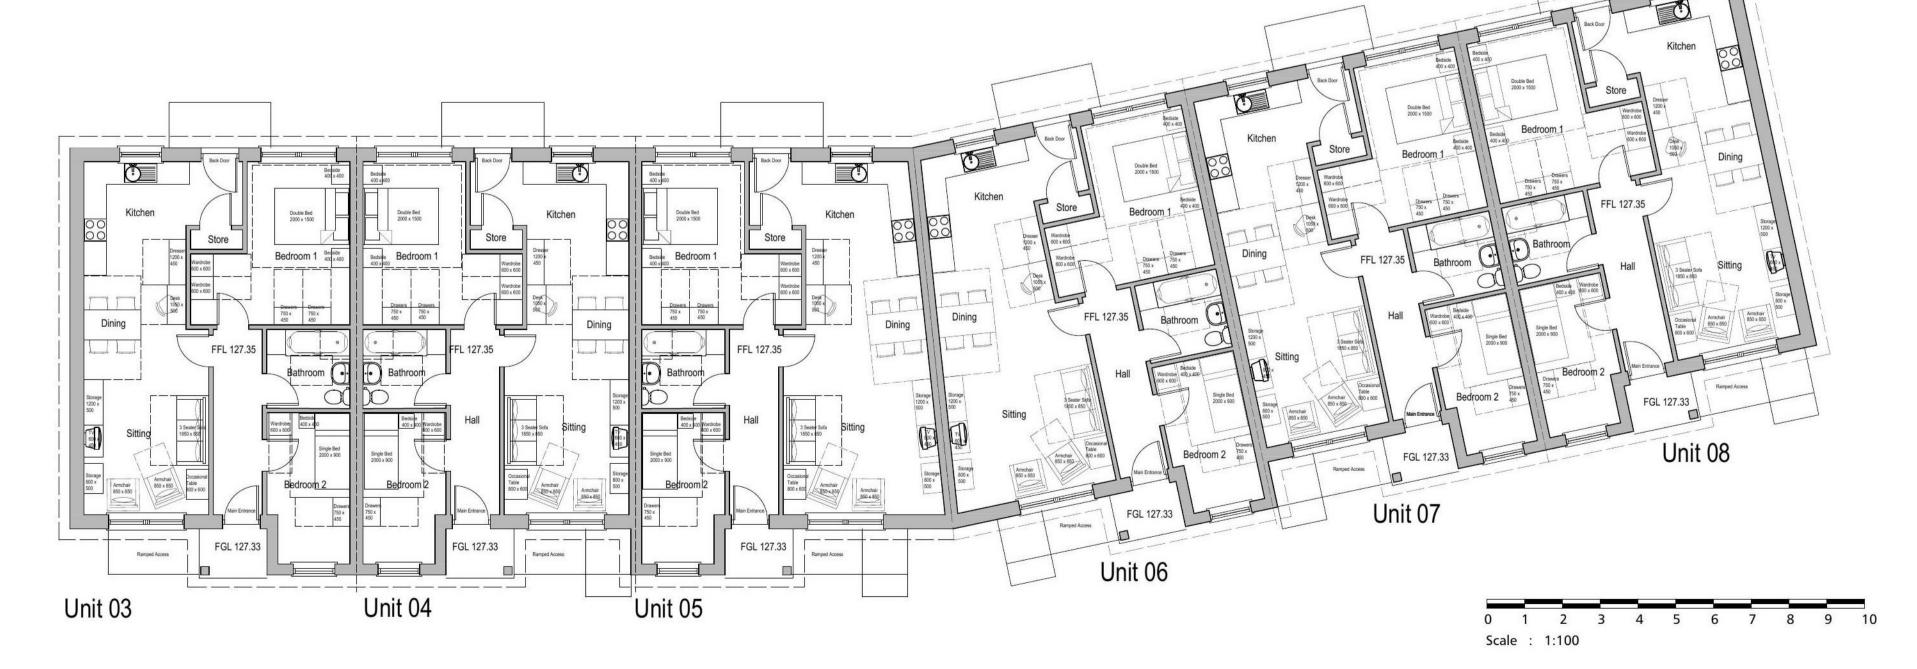

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HEALTH AND SAFETY NOTES: SIGNIFICANT RESIDUAL HAZARDS Health Hazards Structural Instability Ground Conditions Buried and Overhead Services Underground Structures Adjacent Activities

Other (Specify)

DESCRIPTION

Existing soil contamination (previous use as yard for mill) Danger to residents Existing overhead power line and BT line and rising main and main sewer Danger to operatives Access restricted road width and across existing bridge.

DATE BY DETAILS
Date By Note
27/01/2017 KM/RP Revised plans, elevations & section. **ACTIONS / NOTES:**

Contamination report carried out - follow recommendations of specialists Divert existing overhead power line and BT line before construction commences and ensure buildings are safe distance from sewers Railway - noise pollution and hazard to occupants, conflict between operations on site and to rail

Follow recommendations of acoustic report, safe fence to boundary, ensure no plant can oversail railway boundary and site is secure Ensure plant and deliveries are appropriate to site access, check existing bridge can support proposed delivery loads

House Plans as Propose Atholl Estates Housing at Watermill Site


4734

KM,RP 05/12/2016

Blair Atholl

Planning



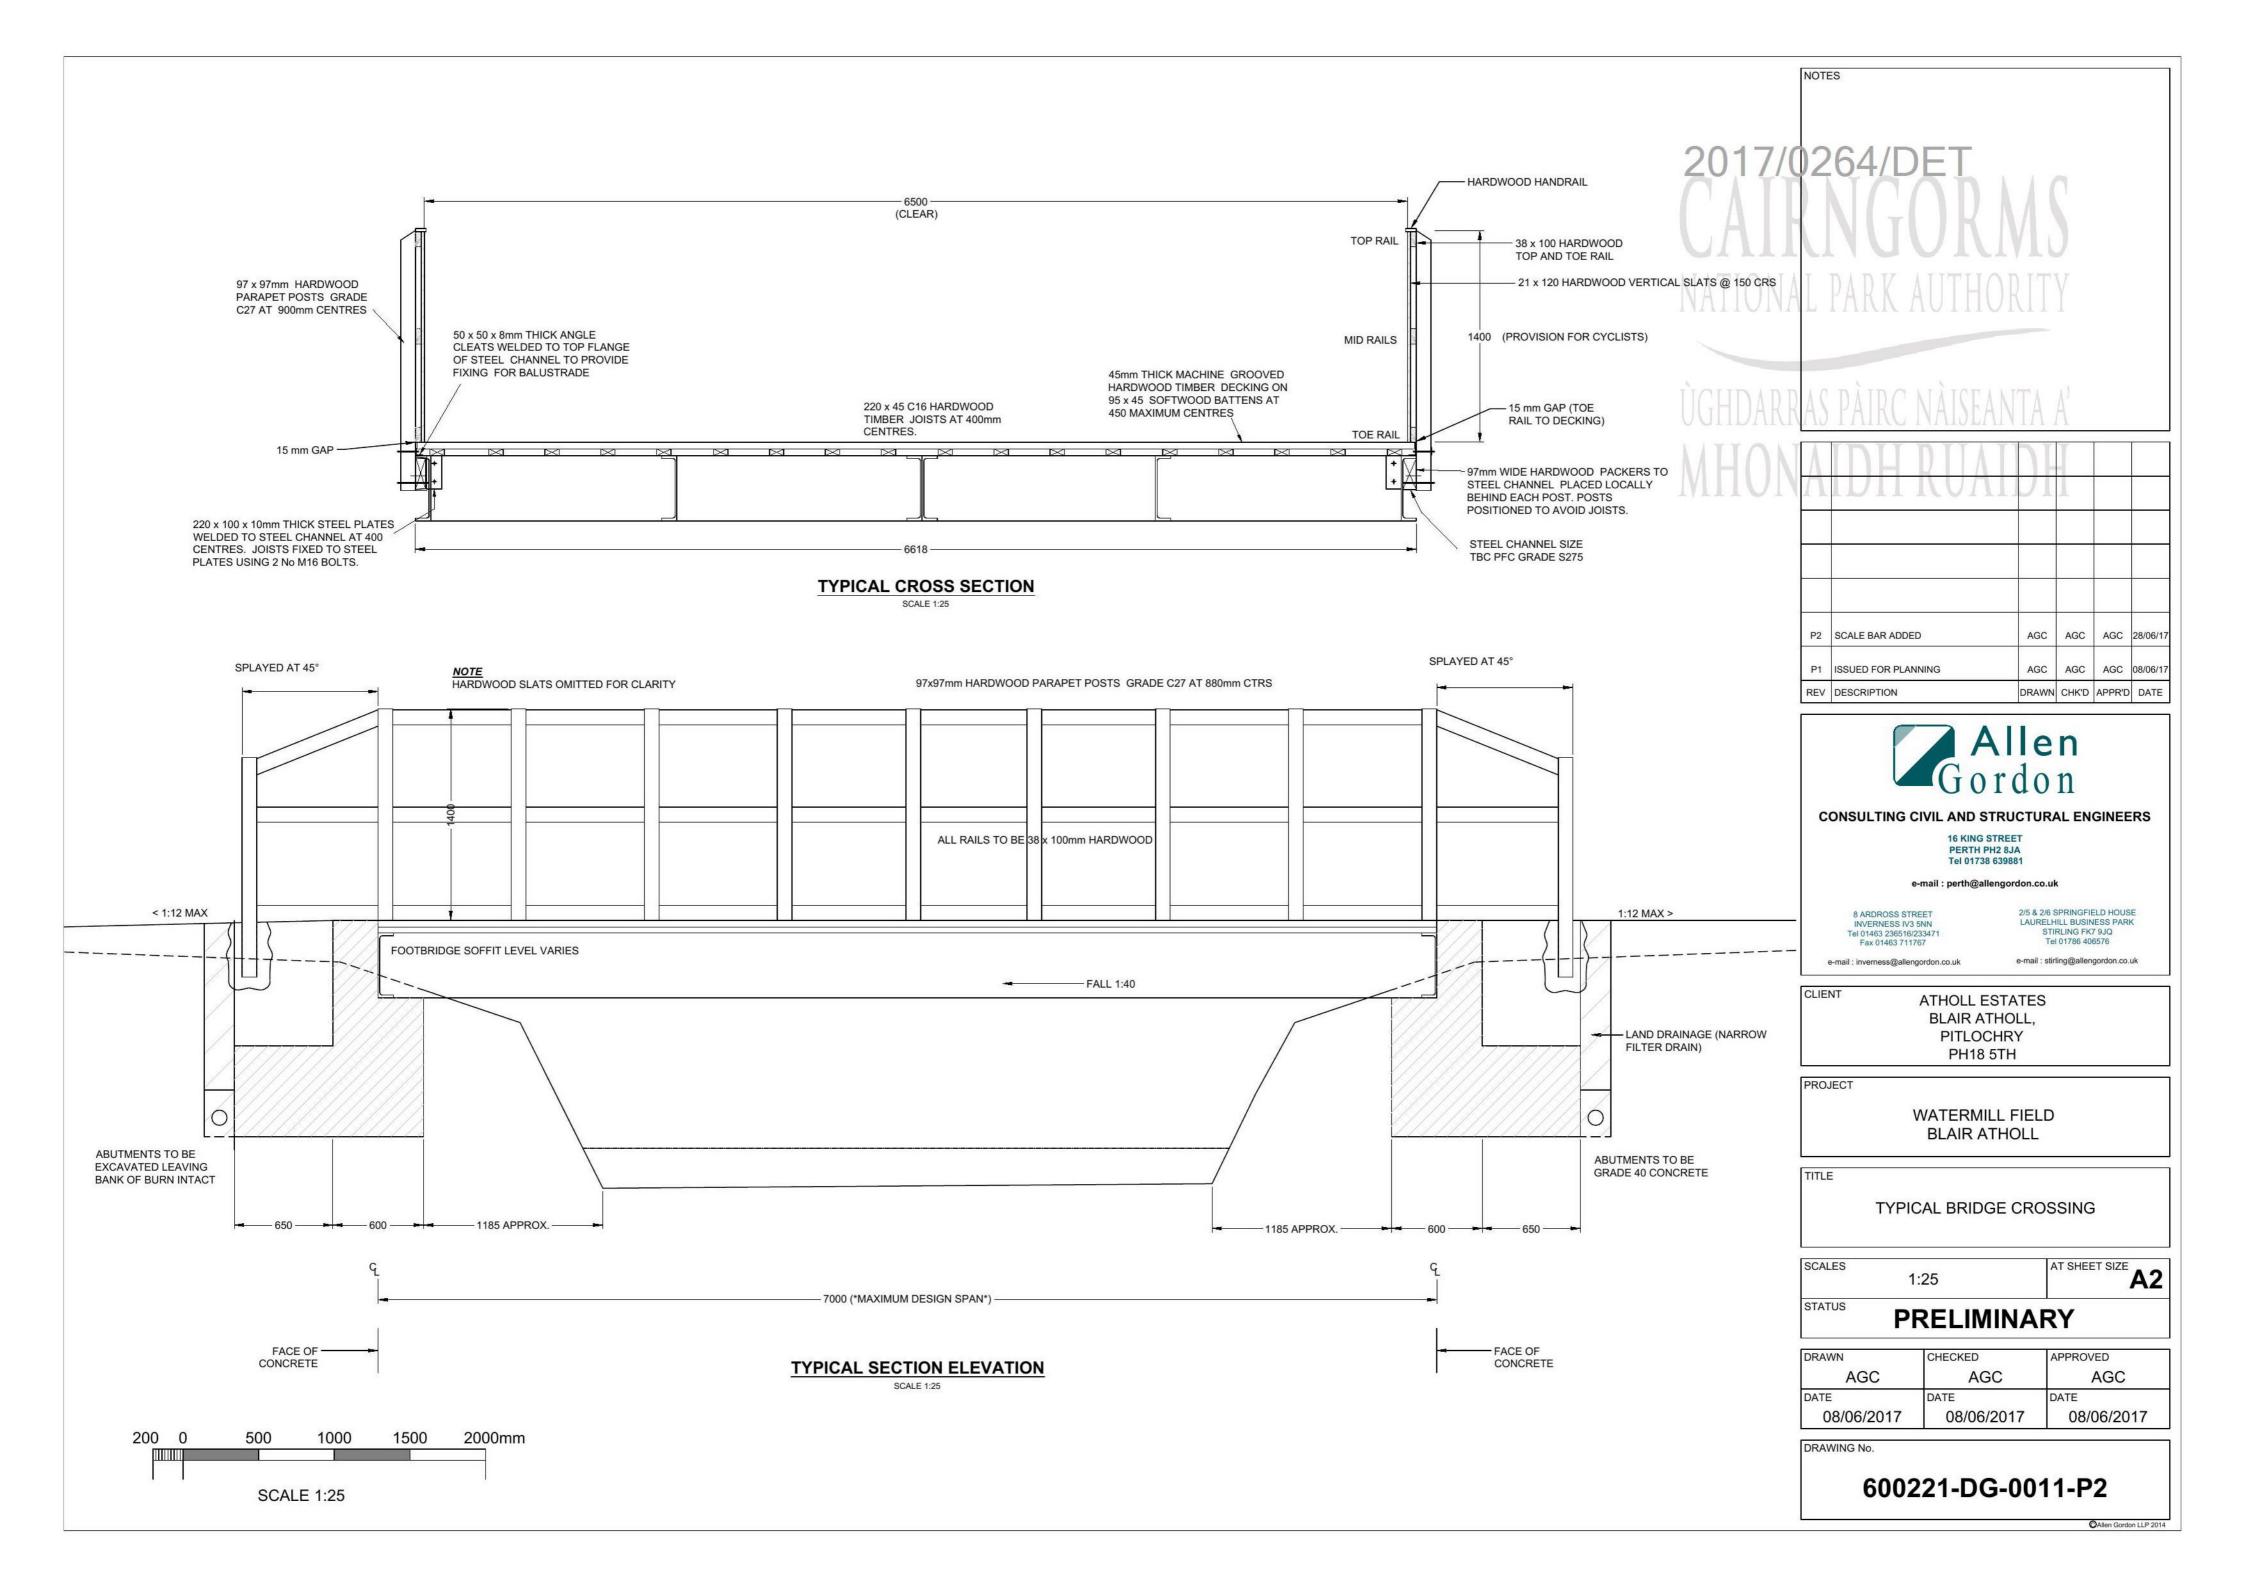



Overhead View from South West



View from South West



View from South



View from East



View from North East



View from South West

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HEALTH AND SAFETY NOTES SIGNIFICANT RESIDUAL HAZARDS PRESENT DESCRIPTION

Other (specify)

1/ Existing soil contamination (previous use as yard for mill) Danger to residents
2/ Existing overhead power line and BT line and Health Hazards Structural Instability rising main and main sewer Danger to operatives Ground Conditions 3/ Railway - noise pollution and hazard to 2 3 4 Buried and Overhead Services occupants, conflict between operations on site Underground Structures and to rail traffic, right of way Adjacent Activities Site Restrictions existing bridge.

REVISIONS REV

ACTIONS / NOTES: 1/ Contamination report carried out - follow recommendations of specialists 2/ Divert existing overhead power line and BT line before construction commences and ensure buildings are safe distance from sewers 3/ Follow recommendations of acoustic report, safe fence to boundary, ensure no plant can oversail railway boundary and site is secure, diversion to right of way with signage 4/ Ensure plant and deliveries are appropriate to site access, check existing bridge can support proposed delivery loads

CLIENT Atholl Estates

PROJECT Housing at Watermill Estate Blair Atholl

Planning

PURPOSE

DRAWN BY DATE RP 6/11/2017

4734

DRAWING TITLE

SCALE NTS JOB NO. DWG. NO.

P04

3D Views of Proposals

PAPER SIZE Α3 REVISION

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C1750.PS1	PLANT SCHE	PLANT SCHEDULE					YEAR
	DETAIL		GIRTH	CLEAR	ROOT	QUANT	OPERATION
LIGHT STANDARD TREES	SD1	SIZE	CIIXIII	STEM	container	Q0/ 11	LOW MAINTENANCE GRASS TO VERGES
Sorbus aucuparia	351	2.5-3.0M	6-8cm	1.2M	-	3	AND AMENITY AREAS AROUND BUILDING
·					grown		CUT & LIFT CUTTINGS SPRING FERTILISER
Betulapendula		2.5-3.0M	6-8cm	1.2M	grown	3	AUTUMN FERTILISER
RUIT TREES	SD2	SIZE	SPACING	STEM	NOTES		WEEDKILL TO ERADICATE CLOVER etc
Malus 'Discovery'		M26 semi-dwarf	As shown	feather	bare root	1	EDGING TO PATHS
Malus 'James Grieve'		M26 semi-dwarf	As shown	feather	bare root	1	WATERING
Malus 'Katy'		M26 semi-dwarf	As shown	feather	bare root	1	
Talua Haly			7 10 01101111				WILD FLORA GRASS AREAS
HEDGE	SD3						CUTS & RAKE OFF
	303	0.9-1.2m	8/lin metre	feather	bare root	320	LICUT CTANDARD & FRUIT TREE DI ANTI
agus sylvatica		0.9-1.2111	o/iiii iiietre		bare root	320	LIGHT STANDARD & FRUIT TREE PLANTI PRUNING
				to base			FIRMING IN
GRASS SEED MIXES							FERTILISER
_ow Maintenance Grass: groGr	een GG1 Universal		760m2	SPOT WEEDKILLER TO TREE PITS			
Wild Flora/Grass: Scotia Seeds MG5 Mix at Sowing Rate 3g/m2						472m2	WATERING
MAINTENANCE TO ALL LANDSCAPE ELEMENTS AS C1750/ MP1							CHECKING STAKES & TIES
							EDGE TURF AROUND PITS
PLANT SCHEDULE							CULTIVATE PIT & ADD BARK MULCH
							HEDGE
							PRUNING TO SIDES & TOP
							FIRMING IN
							FERTILISER
							WEEDKILLER
							WEEDING TO TRENCH
128.69		216 No Fagus	svlvatica				BARK MULCH (SHRUB BEDS)
							WATERING
28.15		hedge plants in	n double st	aggered			CENERAL
20.10	120 20	row at 8 plants	s/lin metre	<u> </u>			GENERAL
	128.38	TOW at 0 plant.	o, iii i iii cii c	•			LITTER CLEARANCE



KEY

YEAR 5

max 22 cuts.

1 application

1 as directed

max 22 cuts.

max 22 cuts.

1 application

1 application

1 application

1 as directed

6 As directed

max22 cuts.

1 application

1 application

1 as directed

1 application

PROPOSED LIGHT STANDARD TREES SEE SD1

PROPOSED FRUIT TREES SEE SD1


PROPOSED HEDGING

SEE SD3

PROPOSED GRASS SEED OR TURF (DEPENDING ON SEASON) SEE SD4 FOR TURF PROPOSED WILD FLOWER SEED MIX SCOTIA SEEDS MG5 MIX

PROPOSED WILD FLOWER SEED MIX SCOTIA SEEDS WET MEADOW MIX IN SUDS AREAS

PROPOSED TARMAC SURFACE: SEE ENGINEERS DRAWINGS

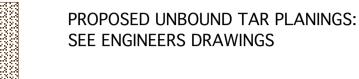

PROPOSED RESIN BOUND PAVING: SEE ENGINEERS DRAWINGS

PROPOSED UNBOUND HOGGIN PROPOSED UNBOUND HOGGIN PAVING: SEE ENGINEERS DRAWINGS

PROPOSED NIDAGRAVEL STABILISED GRAVEL PAVING TO PARKING BAYS: SEE ENGINEERS DRAWINGS

10 METRE WIDE EXCLUSION STRIP FOR SUDS AND TREE PLANTING

REVISIONS

Rev A 20.11.17: Wet Meadow Wild Flower Mix added to SUDS areas.

STATUS OF DRAWING: PLANNING

Client: ATHOLL ESTATES Project: RESIDENTIAL DEVELOPMENT WATERMILL, BLAIR ATHOLL Title: LANDSCAPE LAYOUT

Drg no: C1750.001 Rev: A Date: NOV 2017 Drawn: CP Scale: 1:200 AT A1



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