
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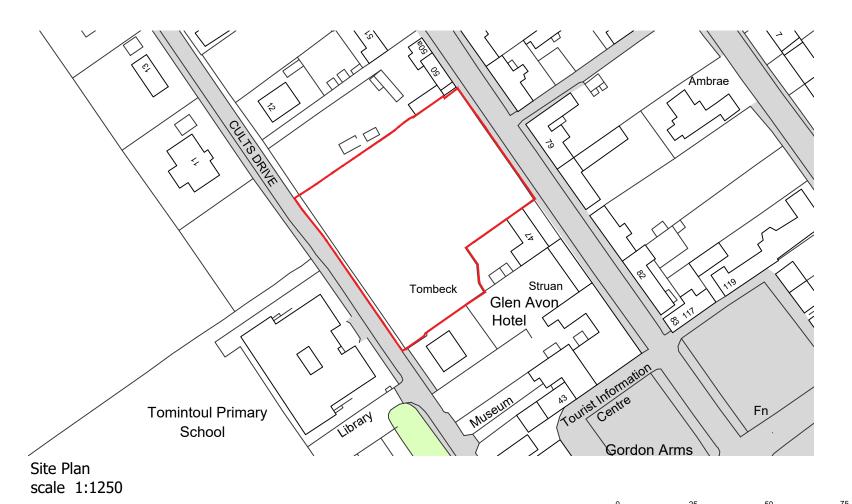
APPENDIX I

2017/0325/DET

**PLANS** 

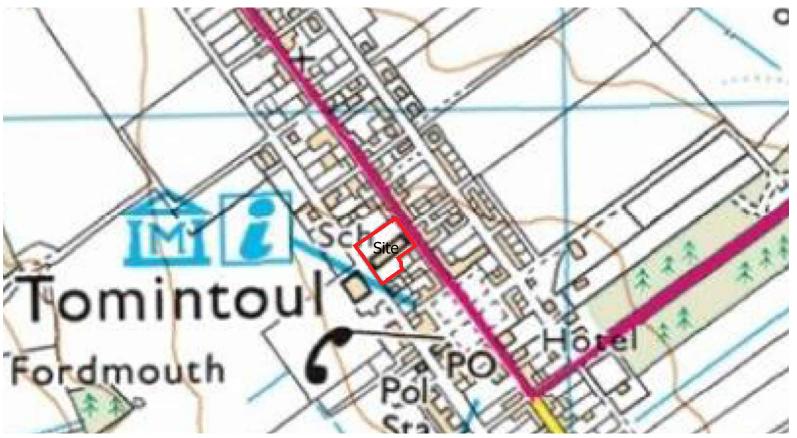


Location Plan scale 1:5000



DO NOT SCALE, IF IN DOUBT PLEASE ASK

All setting out must be checked on site prior to commencement. Any discrepancy must be reported to G. H. JOHNSTON Building Consultants Ltd

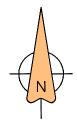

## **PLANNING APPLICATION**

REVI	REVISIONS		
rev.	description	date	

Mr Henry Paget

Project

Redevelopment at Old Secondary School in Tomintoul

**Location Plan** 

Scale VAR@A3	Date 09.16	Drawn by
Project no 2375	Dwg no PL01	Rev

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Scale 1:1250 (metres)



All setting out must be checked on site prior to

site area: 3401 sqm 0.340 ha

## **PLANNING APPLICATION**

REVISIONS			
description	date		
Layout amended	06.12.2017		
Walling amended	09.01.2018		
Bin storage removed & key amended	10.01.2018		
	description Layout amended Walling amended Bin storage removed & key		


Old Secondary School in

Scale	Date	Drawn by
1:500@A3	08.17	PHJ
Project no	Dwg no	Rev
2375	PI 02	C

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## **PLANNING APPLICATION**

REVISIONS		
rev.	description	date

Mr Henry Paget

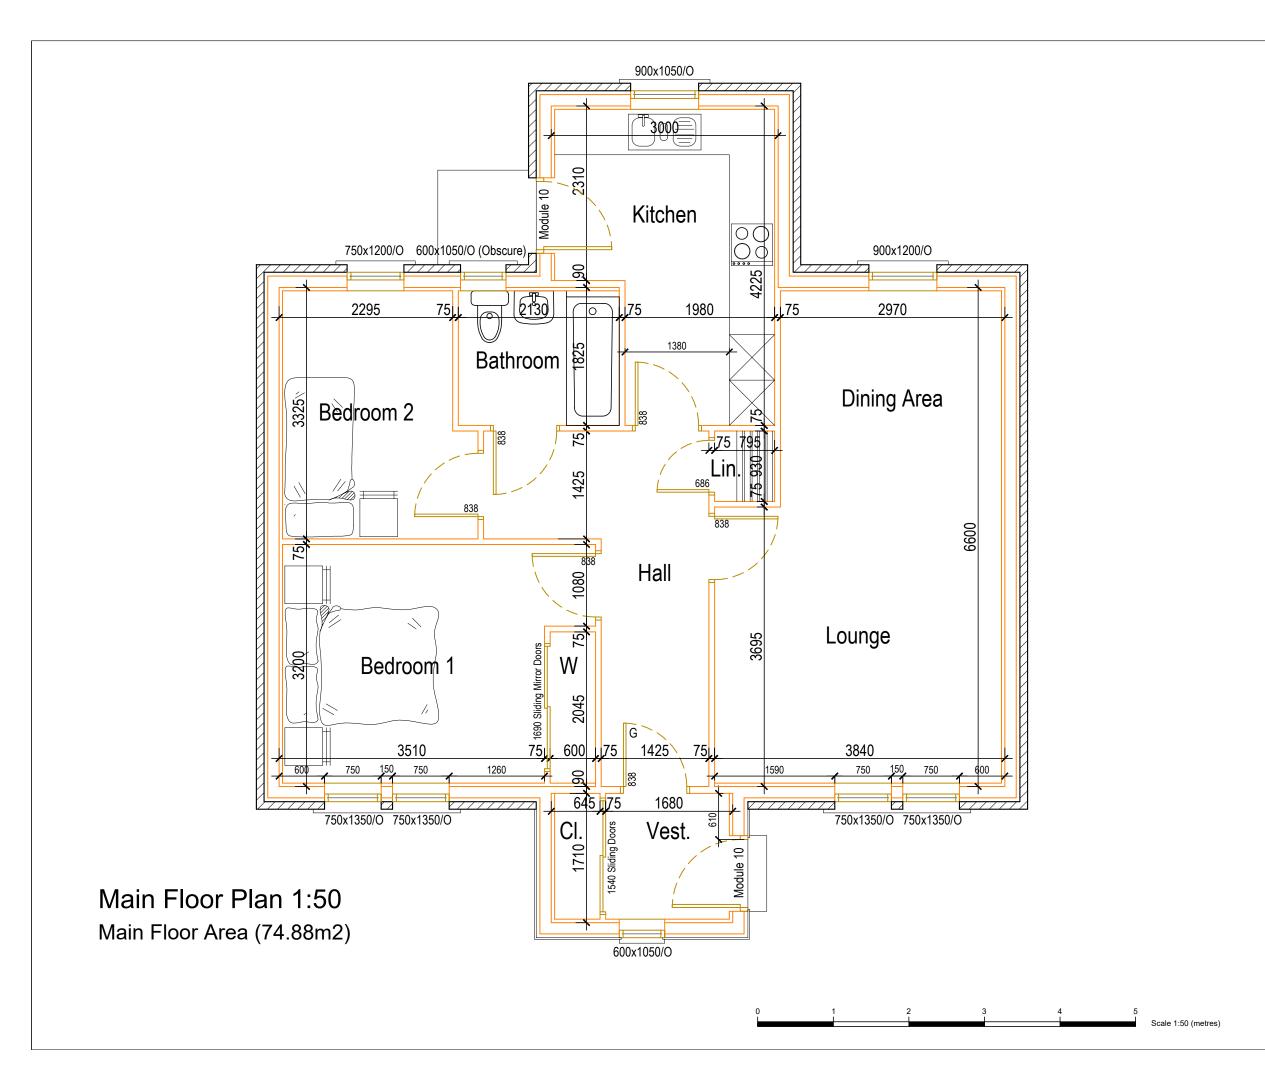Redevelopment at Old Secondary School in Tomintoul

Drawing

Floor Plan


Blackbird: House Type A


1:50@A3	Aug 17	Drawn by PHJ
Project no 2375	Dwg no PL04	Rev

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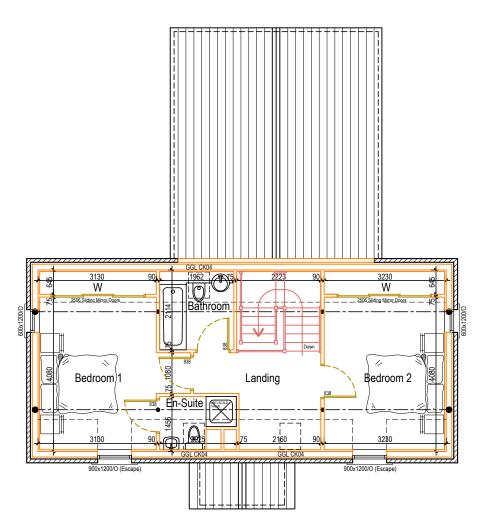
Email: technical@ghjohnston.co.uk



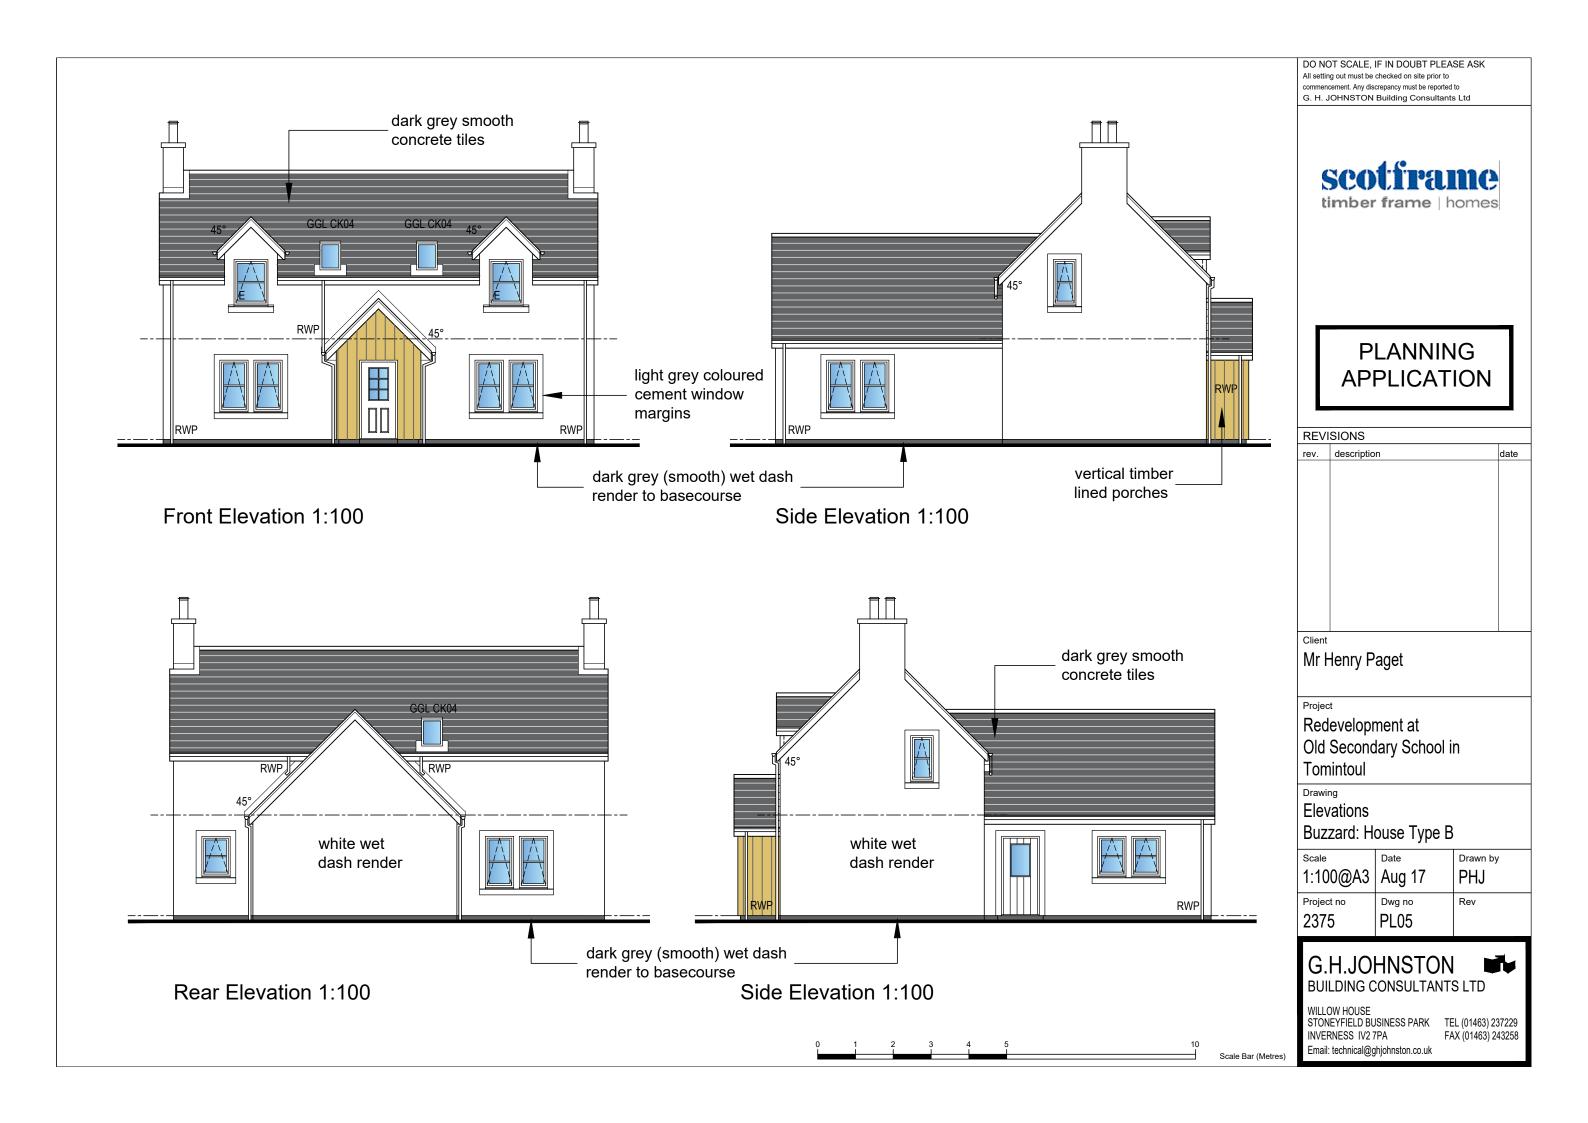

#### Ground Floor Plan 1:100

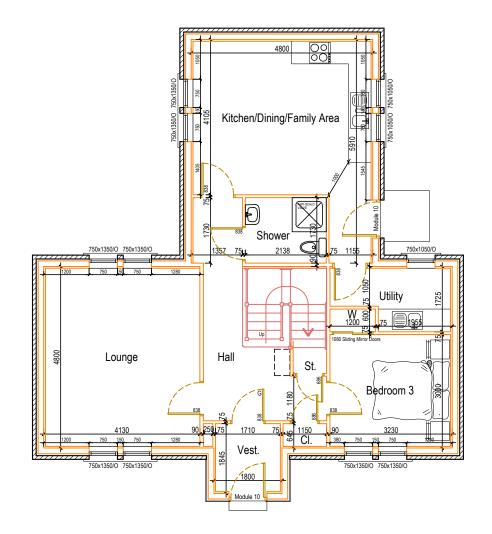Ground Floor Area (82.80m2) Total Floor Area (134.64m2)



First Floor Plan 1:100

First Floor Area (51.84m2)

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## **PLANNING APPLICATION**

REVI	SIONS	
rev.	description	date

Mr Henry Paget

Redevelopment at Old Secondary School in Tomintoul


Drawing

Floor Plan Buzzard: House Type B

Drawn by 1:100@A3 Aug 17 PHJ Project no Dwg no Rev 2375 PL06

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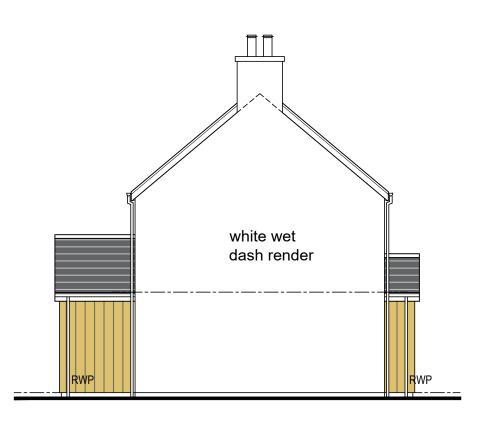


#### Front Elevation 1:100

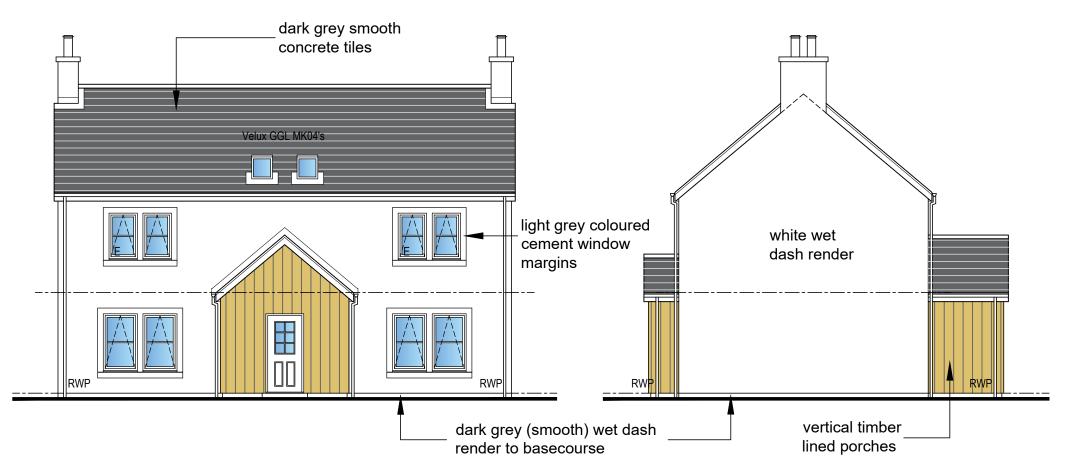

Rear Elevation 1:100

Side Elevation 1:100



Side Elevation 1:100

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## **PLANNING APPLICATION**

REV	REVISIONS	
rev.	description	date

Mr Henry Paget

Redevelopment at Old Secondary School in Tomintoul

Drawing

Elevations


Eider: House Type C

Scale	Date	Drawn by
1:100@A3	Aug 17	PHJ
Project no	Dwg no	Rev
2375	PL07	

## **G.H.JOHNSTON**




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Ground Floor Plan 1:100

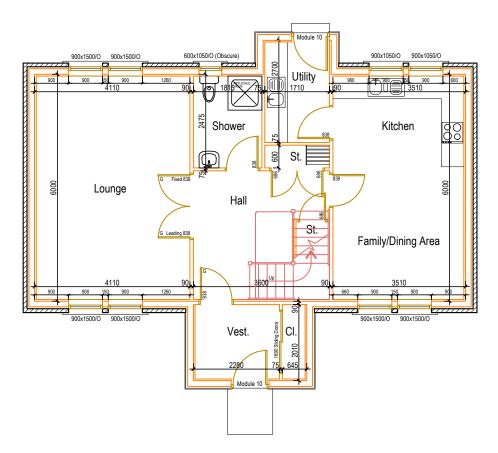Ground Floor Area (76.32m2) Total Floor Area (144.72m2)



First Floor Plan 1:100

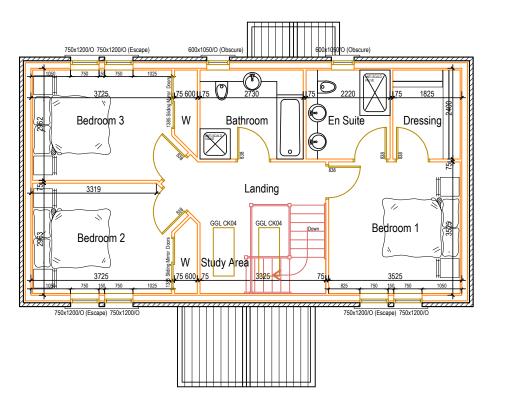First Floor Area (68.40m2)

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## **PLANNING APPLICATION**

REVISIONS		
rev.	description	date

Mr Henry Paget

Redevelopment at Old Secondary School in **Tomintoul** 

Drawing

Floor Plan


Eider: House Type C

Scale 1:100@A3	Aug 17	Drawn by PHJ
Project no 2375	Dwg no PL08	Rev

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Scale 1:100 (metres)



## **PLANNING APPLICATION**
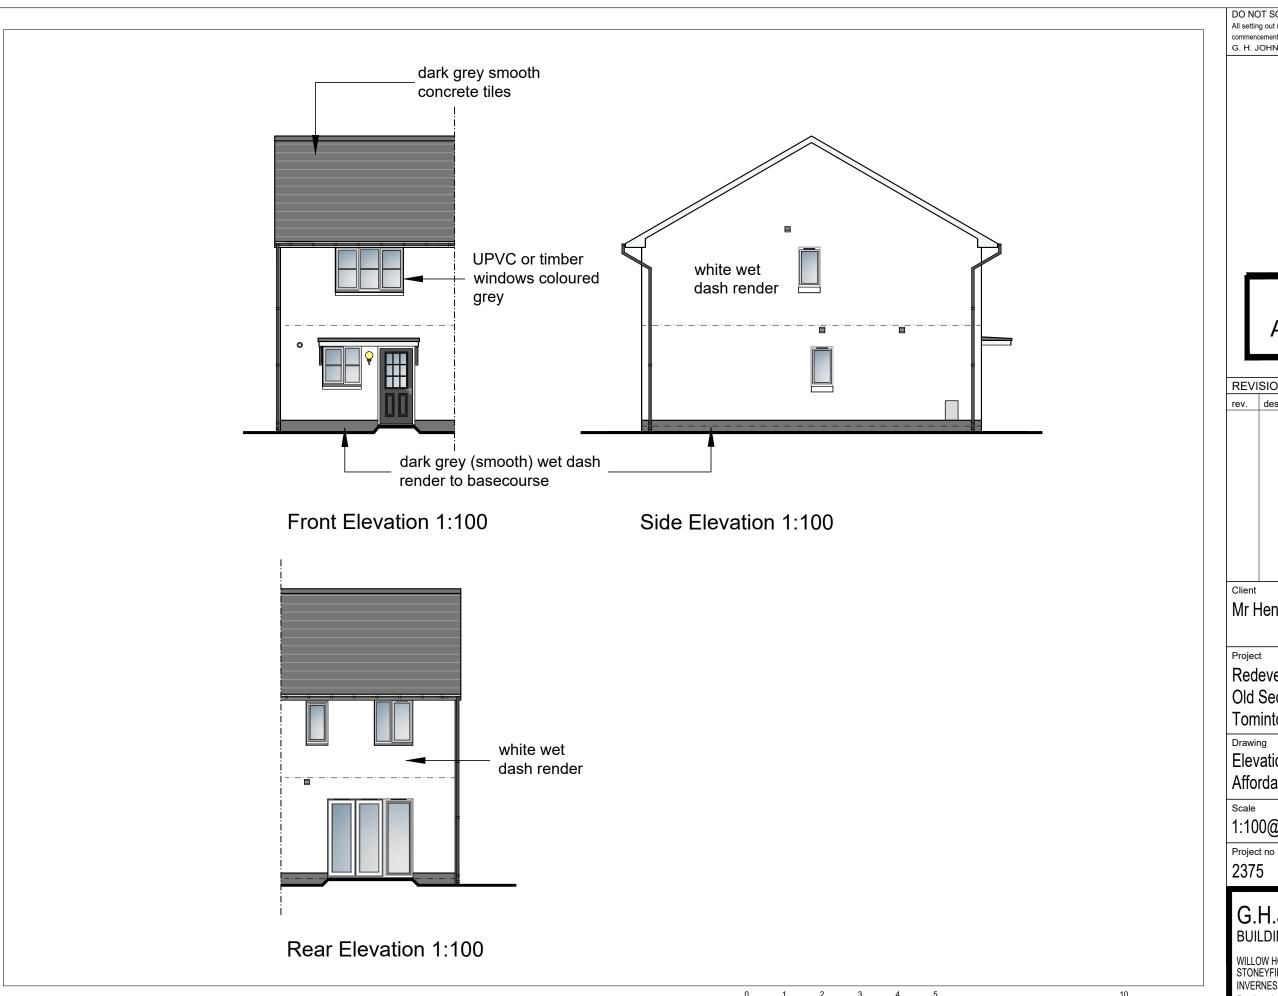
# REVISIONS rev. description

Mr Henry Paget


Redevelopment at Old Secondary School in Tomintoul

Elevations

Affordable: House Type D


Scale	Date	Drawn by
1:100@A3	Aug 17	PHJ
Project no	Dwg no	Rev
2375	PL09	

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## **PLANNING APPLICATION**

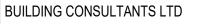

Mr Henry Paget

Redevelopment at Old Secondary School in Tomintoul

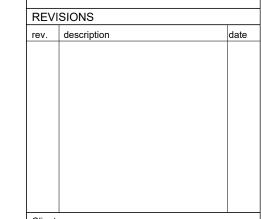Drawing

Floor Plan

Affordable: House Type D

7.			
	Scale	Date	Drawn by
	1:100@A3	Aug 17	PHJ
	Project no	Dwg no	Rev
	2375	PL10	

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BEDROOM 2




**End Terrace** 

First Floor Plan 1:100

Middle Terrace

Ground Floor Plan 1:100

First Floor Plan 1:100

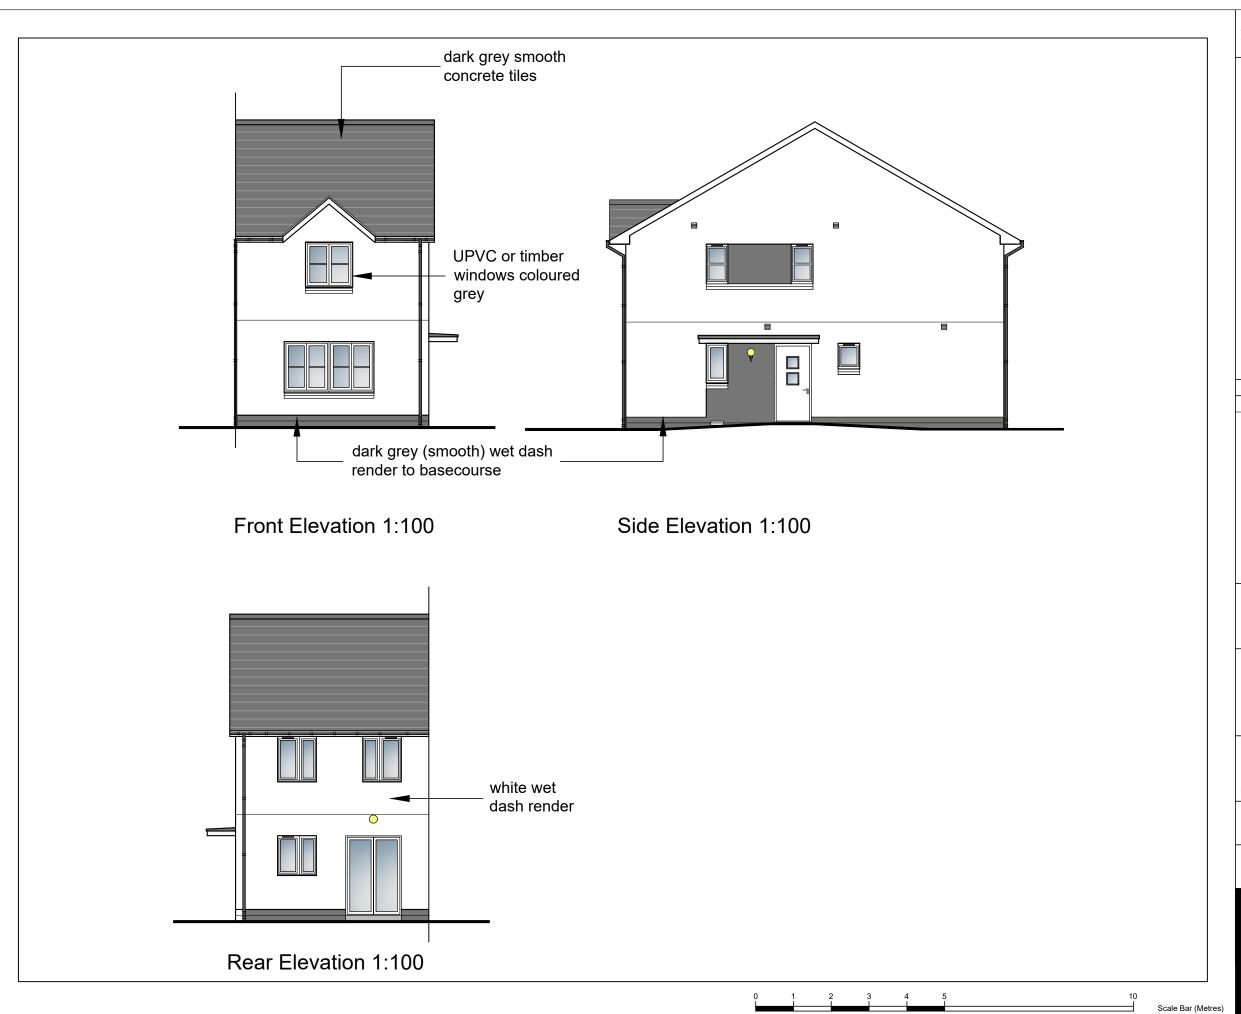


## **PLANNING APPLICATION**

## REVISIONS rev. description Mr Henry Paget Redevelopment at Old Secondary School in Tomintoul Drawing Elevations Affordable: House Type E Drawn by 1:100@A3 Aug 17 PHJ Project no Dwg no Rev 2375 PL11

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## **PLANNING APPLICATION**

date

Mr Henry Paget

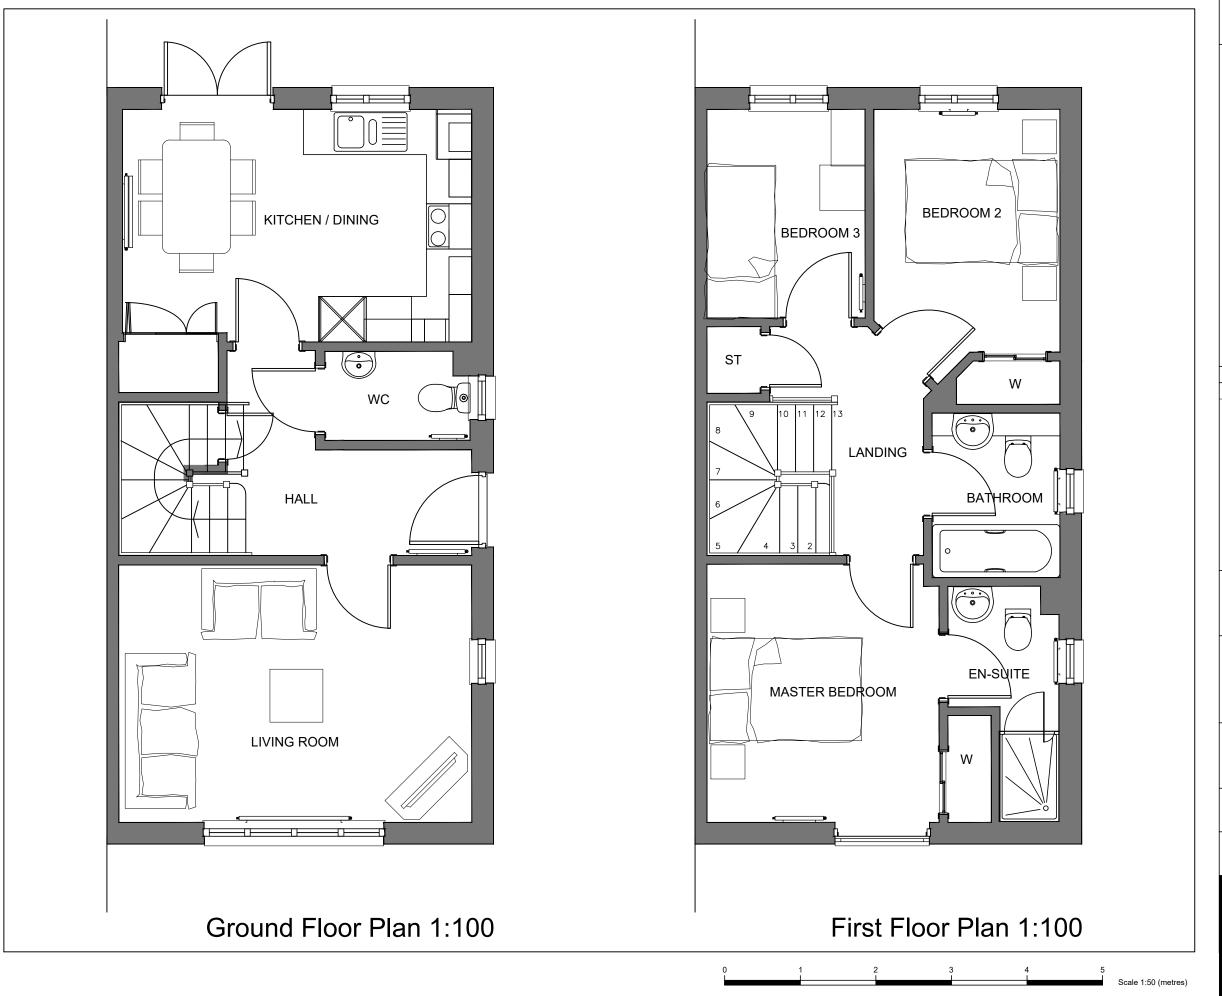Redevelopment at Old Secondary School in **Tomintoul** 

Drawing

Floor Plan


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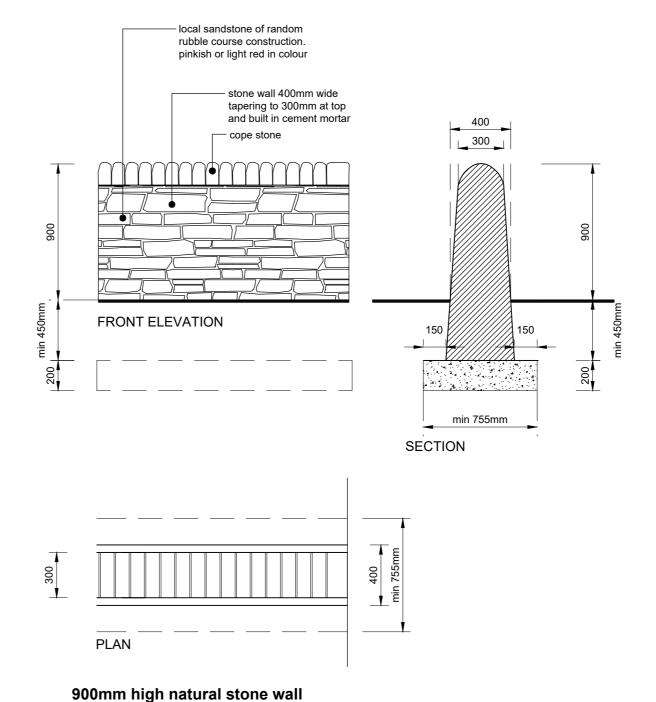
Scale	Date	Drawn by	
1:50@A3	Aug 17	PHJ	
Project no	Dwg no	Rev	
2375	PL12		

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PLANNING APPLICATION

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REVISIONS
rev. description date

Mr Henry Paget

Project

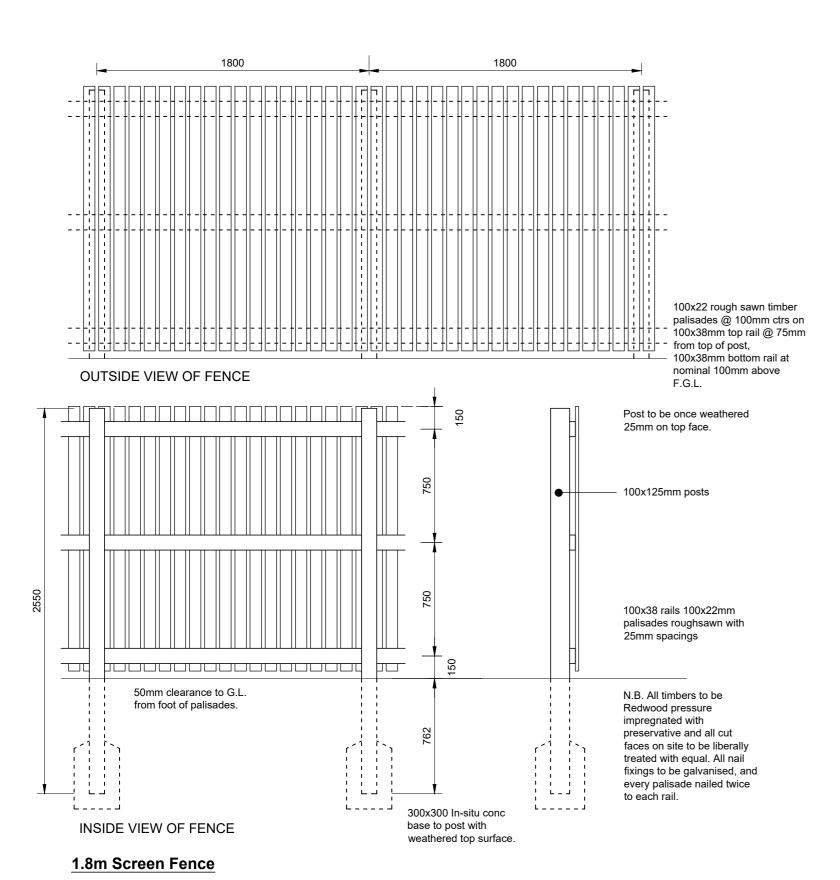Redevelopment at
Old Secondary School in
Tomintoul

Drawing

Fence & natural stone wall details

Scale 1:25@A2	Date Dec 2017	Drawn by
Project no 2375	Dwg no PL13	Rev


MITOME

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0 1 2 2.5 Scale 1:25 (metres)



#### TREE PROTECTION MEASURES

This Tree Protection Plan shows the position of tree protective fencing and other protective measures to be observed during development of the site.

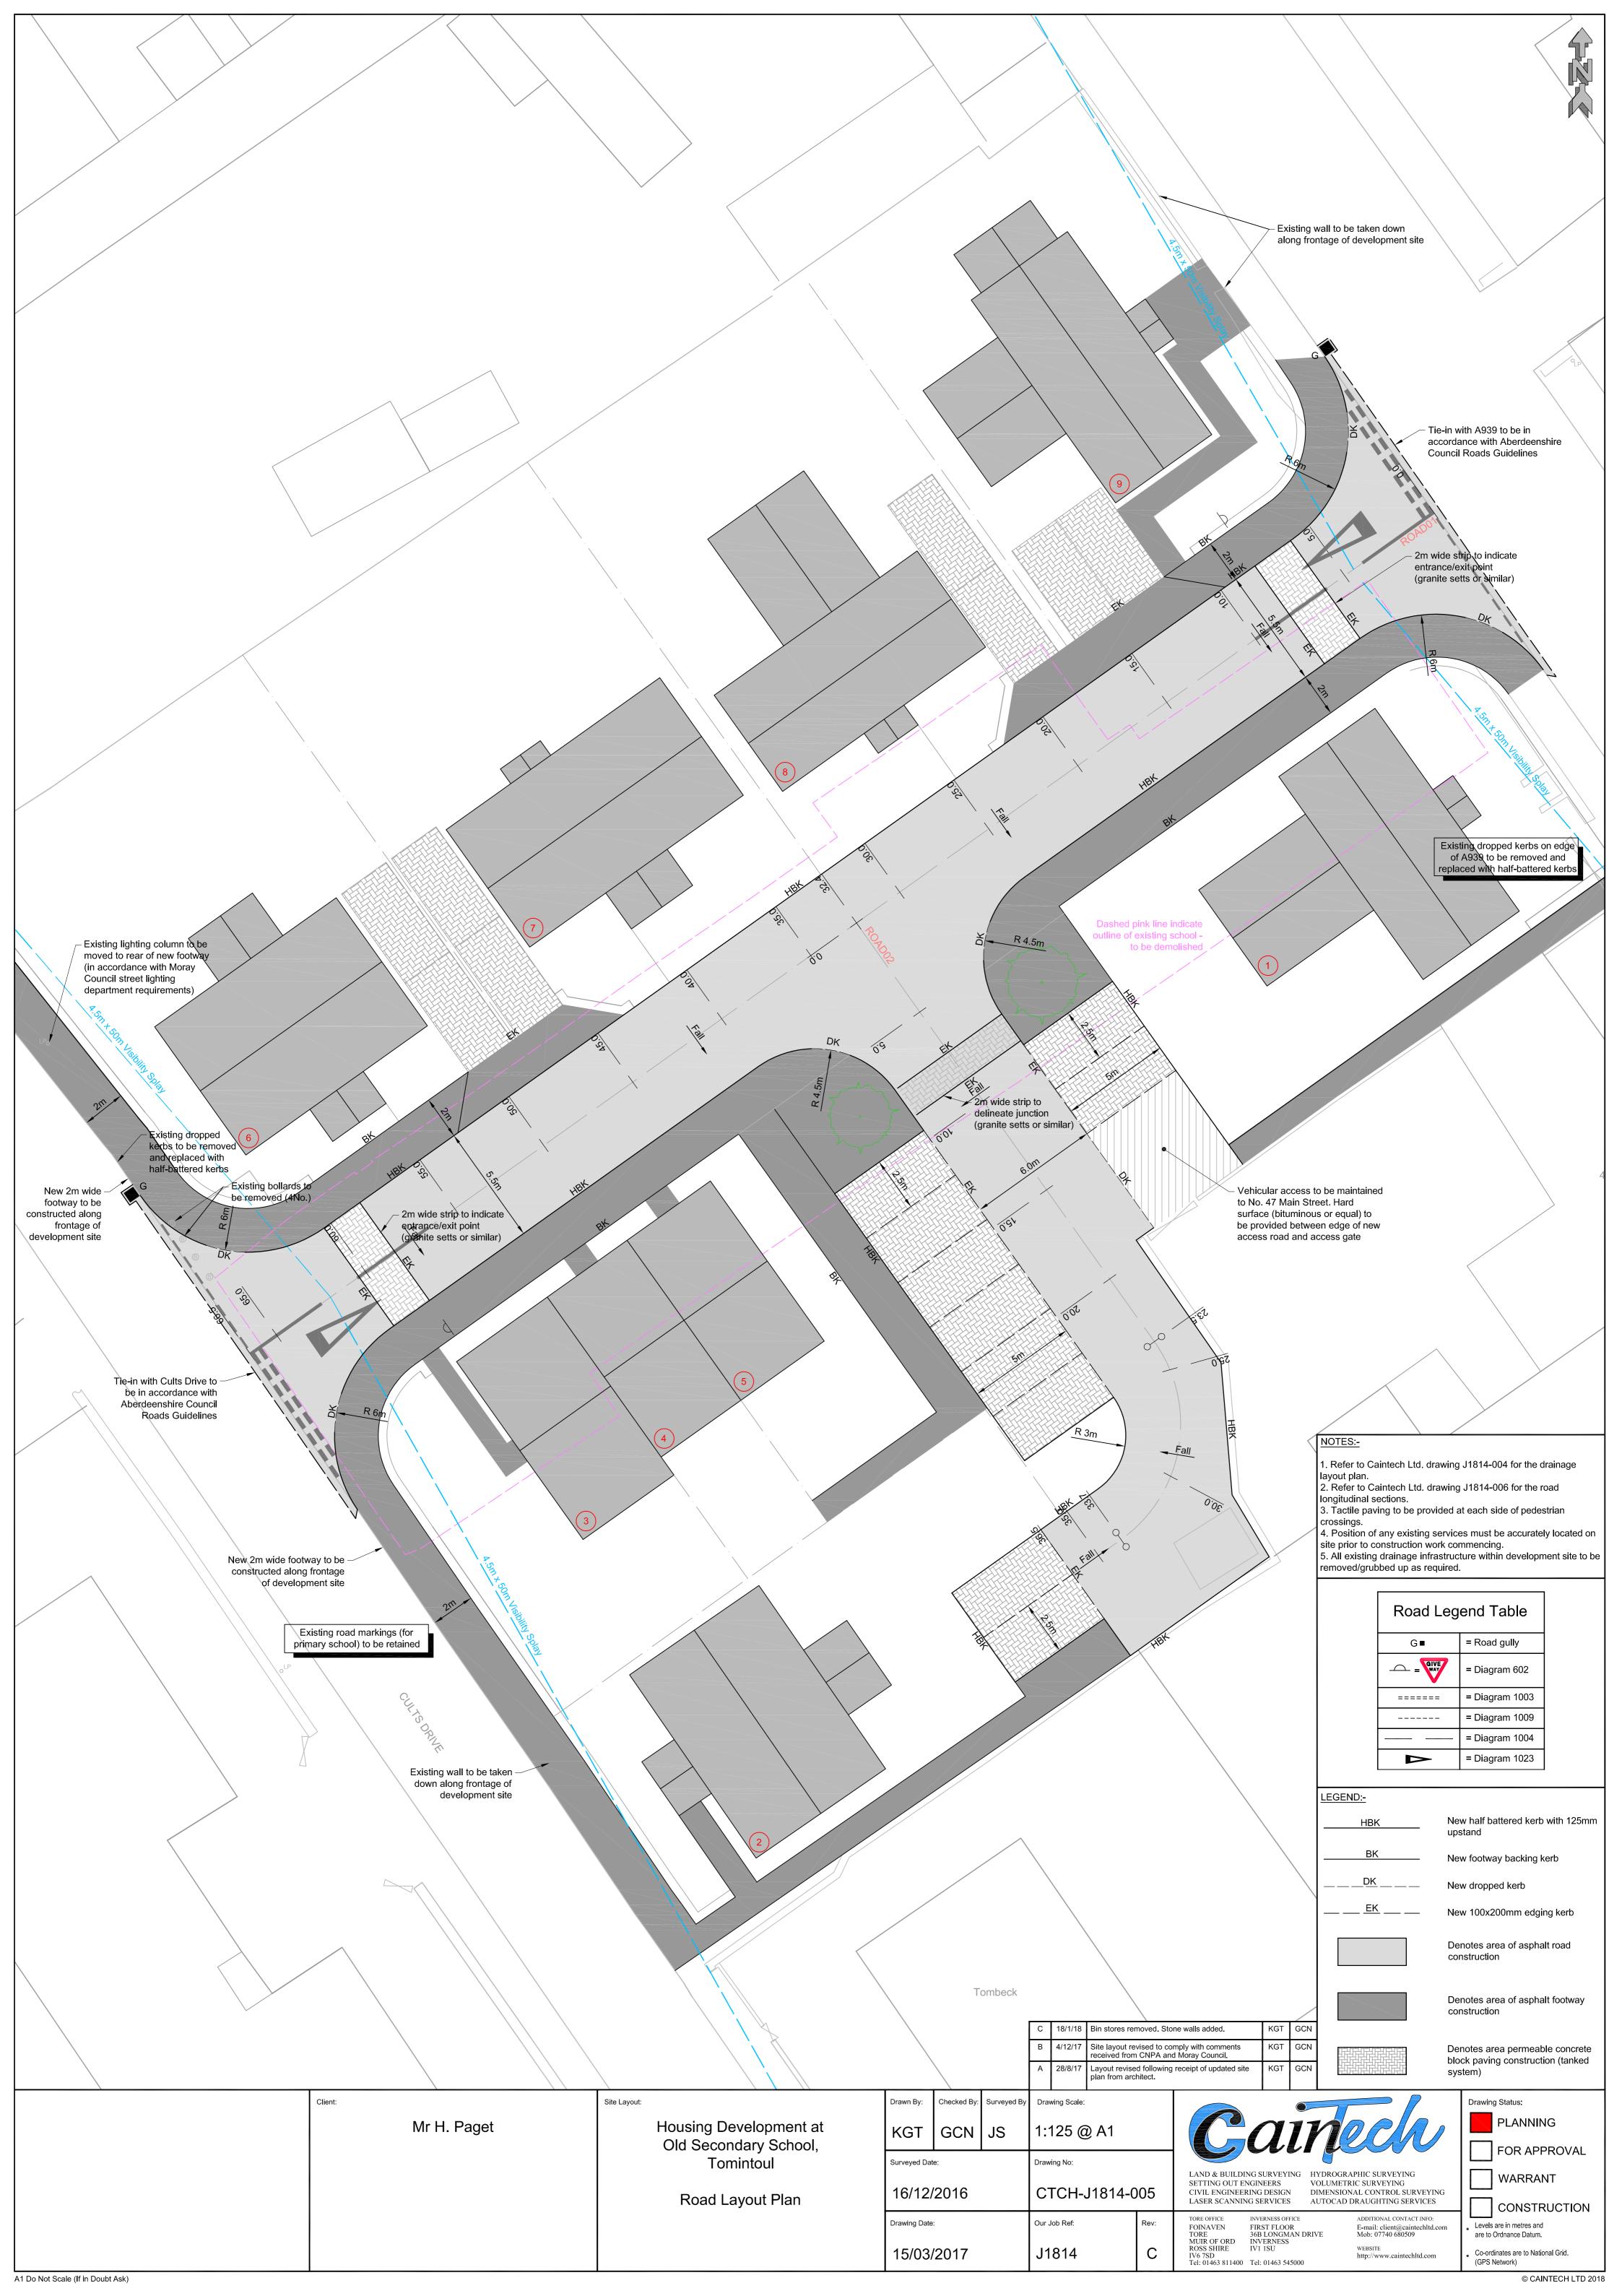All the protective measures must be installed prior to any of the following taking place:

plant and material delivery
 demolition work
 soil stripping/excavations
 construction works
 installation of utilities

Once erected the area protected by protective fencing is to be regarded as sacrosanct. The fencing must not be removed or altered without prior approval of the appointed arboricultural advisor or the planning authority's tree officer.

Typical tree protective fencing shall comprise of interlocking weldmesh panels supported by a well braced scaffold set firmly into the ground (see specifications below). Any proposals for alternative barrier specifications must first be approved by the local planning authority. Further guidance on generally accepted alternatives can be provided by the project arboricultural advisor.

Once the Root Protection Areas have been protected by barriers and/or ground protection, construction work can commence. Weatherproof notices must be attached to the barriers clearly indicating their purpose (see examples in Figure 1 below).



Figure 1: Tree Protective Fence Signage

### TREE PROTECTIVE FENCING – SPECIFICATION

The protective fencing must consist of either a timber or steel scaffold framework comprising horizontal and vertical timbers/scaffold tubes well braced to resist impacts. British standard requires a scaffold tube framework with fencing panels attached (see Figure 2 below). However, the LPA may accept a fence based on the same design but constructed with timber.

For a timber framework the vertical posts (at least 100 mm²) must be spaced that the maximum interval of 3m. The barrier should comprise Heras® type fence panels, three-quarter inch timber sheets or chain link fencing securely fastened to the three horizontal rails (at least 25 mm x 100 mm in cross-section). Timber braces must be added to give the fence rigidity. The overall dimensions of the fence must closely correlate with those given in Figure 2, which is based on the steel scaffold specification outlined in British Standard BS 5837 2012.


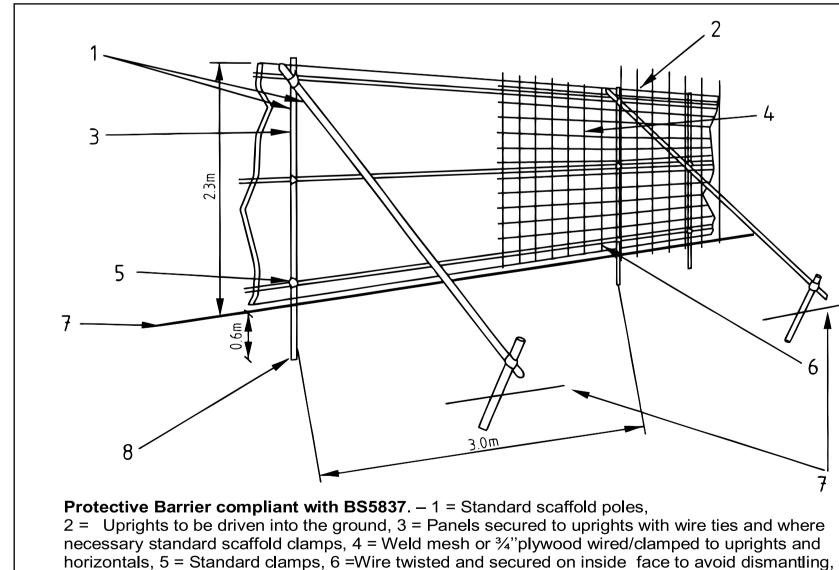


Figure 2: BS5837- Tree Protective Fence Specification


7 = ground level, 8 = Approx. 0.6m driven into ground

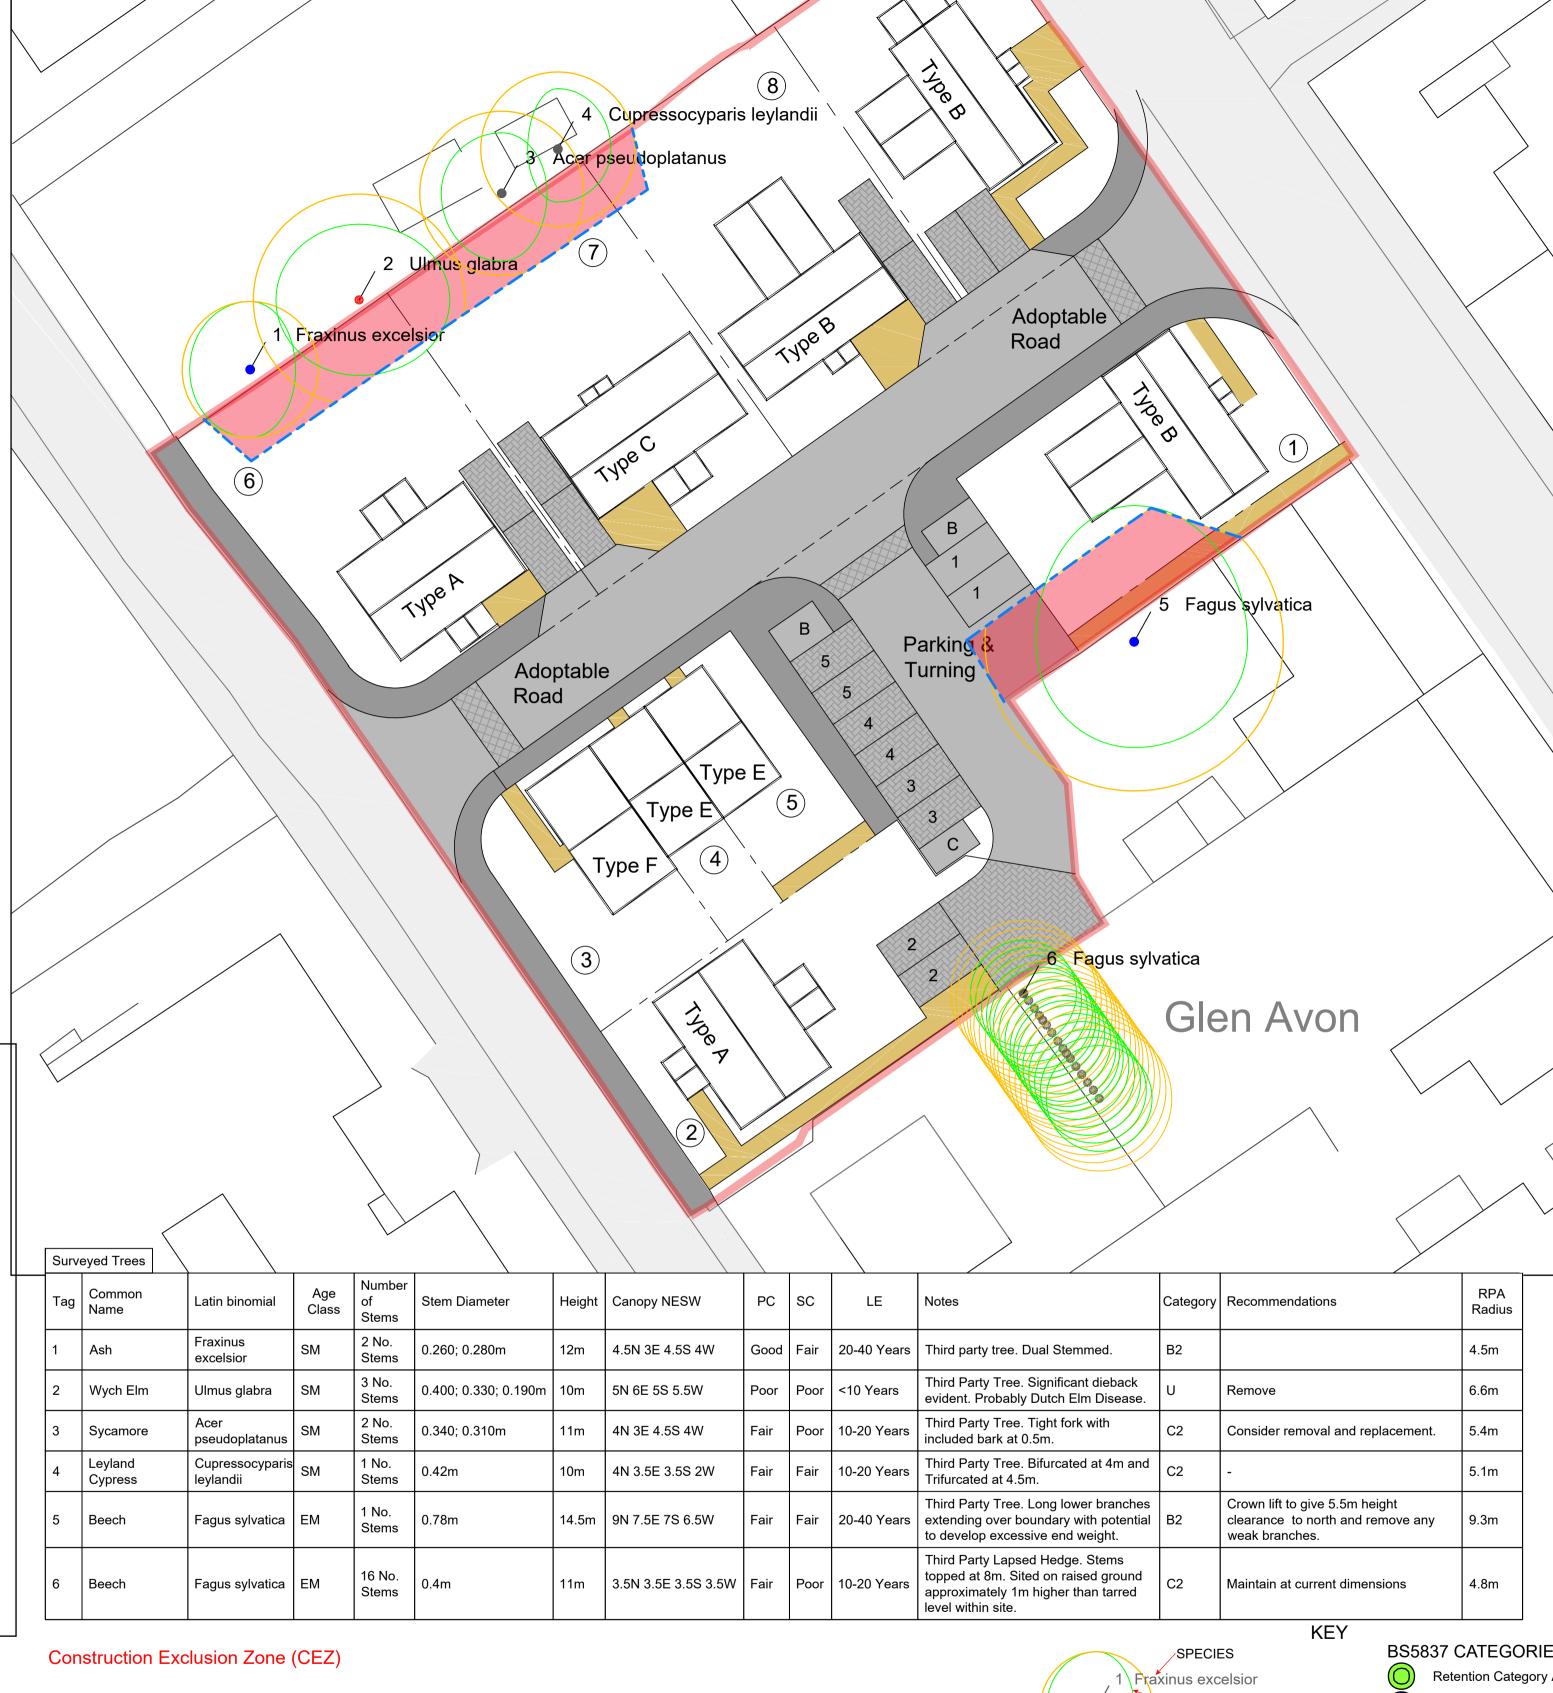

The existing tar surface and any base material must be lifted under the supervision of a suitably qualified arboricultural consultant and the tree protective fencing erected prior to building demolition.

The use of a mechanical excavator (working with a non-toothed bucket) is permissible for removal of the tar surfacing within the CEZ. The work must be conducted such that the machine is always working from a consolidated tarred surface or from outside of the CEZ. Any fill/sub base material below the tar must be removed by hand taking care to prevent damage to tree roots. The CEZ must remain protected and undisturbed for the duration of the demolition and construction unless further works are required within the CEZ.

Any works planned within the CEZ must be approved by the Local Planning Authority. To gain LPA approval it will be necessary to provide an Arboricultural Method Statement together with the contractors Risk Assessment Method Statement clearly demonstrating how the works can be conducted safely whilst minimising the risk of damage to trees/tree roots.

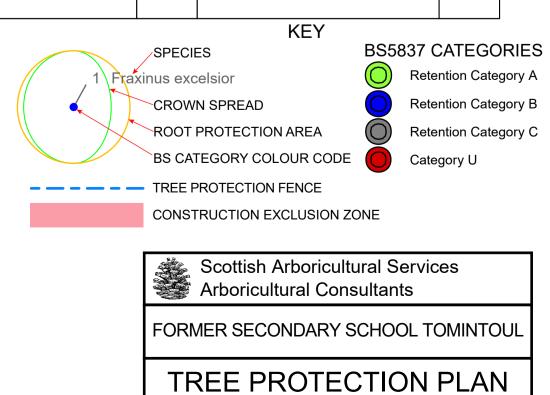

1:250 AT A1

 $\mathsf{SM}$