AGENDA ITEM 6


APPENDIX IB

2020/0193/DET


PLANS



FRONT ELEVATION

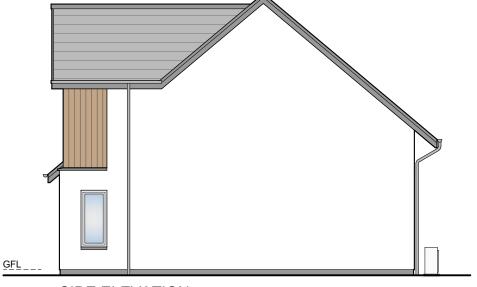

SIDE ELEVATION

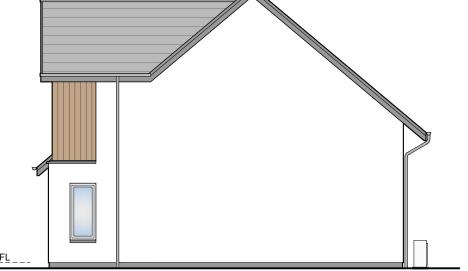

All colours as External Finishes Schedule

(07) Timber cladding

01) Smooth render basecourse


Galvanised steel gutters and downpipes

02) Render finish

03 uPVC windows

05 Concrete slip cills

06) Concrete tiles

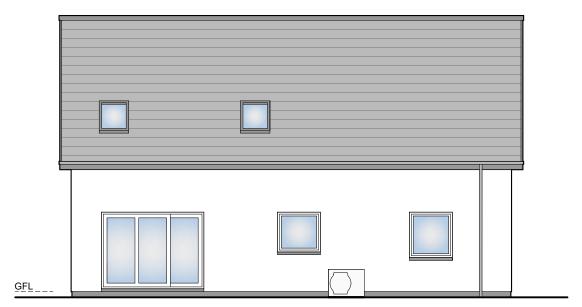

REAR ELEVATION

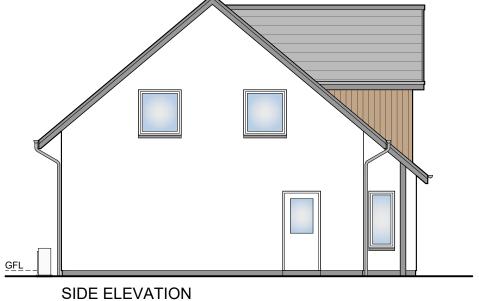




IMAGE 1 - FRONT PERSPECTIVE



IMAGE 2 - REAR PERSPECTIVE

1 : 100	0 1m 2m 3m	6m
	-	-
REV DATE	DESCRIPTION	DRN

Bracewell Stirling CONSULTING

38 WALKER TERRACE, TILLICOULTRY, FK13 6EF 5 NESS BANK, INVERNESS, IV2 4SF 15 LOCHSIDE STREET, OBAN, PA34 4HP


01463 233760

NEW HOUSING, DUNBARRY TERRACE KINGUSSIE


DAVALL DEVELOPMENTS LTD

HOUSE TYPE D (4BC 166) - ELEVATIONS


SCALE: PAPER SIZE:	1 : 100 A3	DRAWN: DATE:	PL Sep 2019
DWG No.	4562-01-	107	REV.

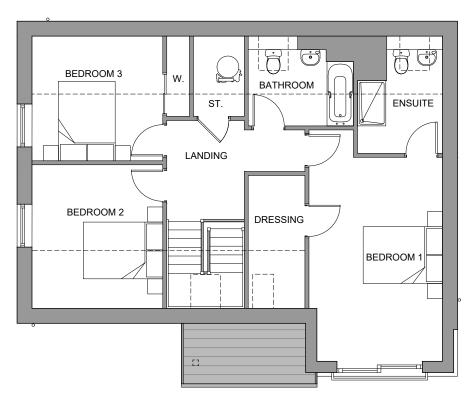

FIRST FLOOR PLAN

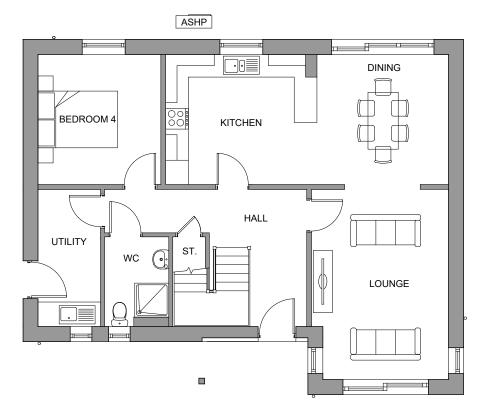

GROUND FLOOR PLAN

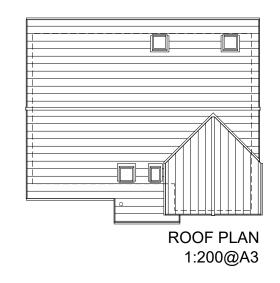



Bracewell Stirling CONSULTING

38 WALKER TERRACE, TILLICOULTRY, FK13 6EF 5 NESS BANK, INVERNESS, IV2 4SF 15 LOCHSIDE STREET, OBAN, PA34 4HP

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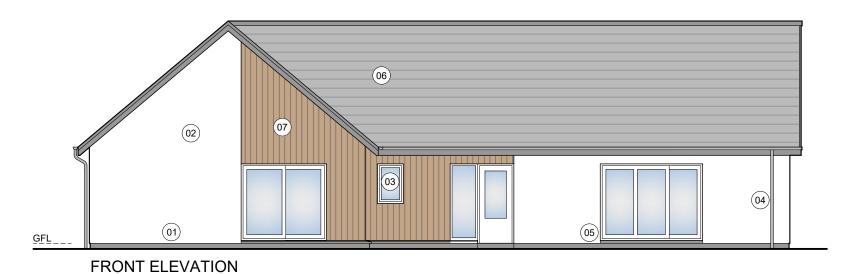
NEW HOUSING, DUNBARRY TERRACE KINGUSSIE

DAVALL DEVELOPMENTS LTD

HOUSE TYPE D (4BC 166) - PLANS

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3m	6m	PAPER SIZE:	A3	DATE:	Sep 2019
		DWG No.	4562-01-	106	REV.


1:100 0 1m 2m



GFL...

SIDE ELEVATION



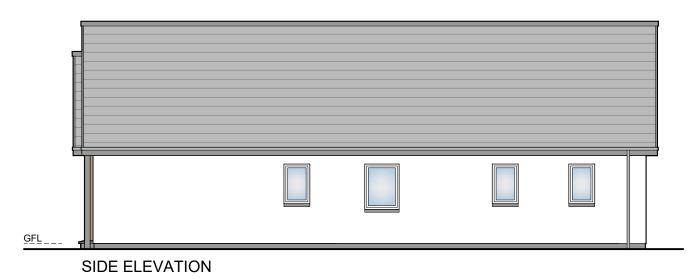

REAR ELEVATION

- 01) Smooth render basecourse
- 02 Render finish
- 03) uPVC windows
- Galvanised steel gutters and downpipes
- 05 Concrete slip cills
- 06) Concrete tiles
- (07) Timber cladding

All colours as External Finishes Schedule



IMAGE 1 - FRONT PERSPECTIVE



IMAGE 2 - REAR PERSPECTIVE

1:100 0 1m 2m 3m 6m

Bracewell Stirling CONSULTING

38 WALKER TERRACE, TILLICOULTRY, FK13 6EF 5 NESS BANK, INVERNESS, IV2 4SF 15 LOCHSIDE STREET, OBAN, PA34 4HP

REV DATE DESCRIPTION


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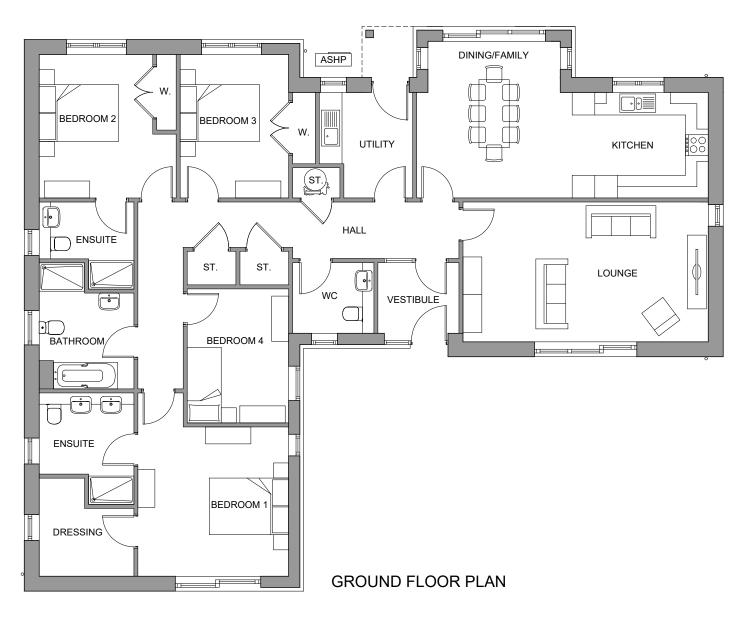
NEW HOUSING, DUNBARRY TERRACE KINGUSSIE


DAVALL DEVELOPMENTS LTD

HOUSE TYPE E (4BB 168) - ELEVATIONS

SCALE:	1 : 100	DRAWN:	PL
PAPER SIZE:	A3	DATE:	Sep 2019
DWG No.	4562-01-	109	REV.



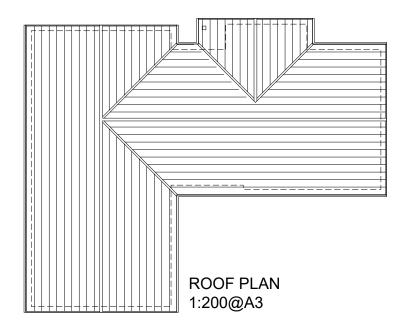

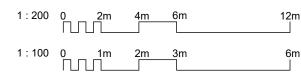



Bracewell Stirling CONSULTING

38 WALKER TERRACE, TILLICOULTRY, FK13 6EF 5 NESS BANK, INVERNESS, IV2 4SF 15 LOCHSIDE STREET, OBAN, PA34 4HP

01259 750301 01463 233760 01631 359054

NEW HOUSING, DUNBARRY TERRACE KINGUSSIE

DAVALL DEVELOPMENTS LTD

HOUSE TYPE E (4BB 168) - PLANS

SCALE:	1 : 100	DRAWN:	PL
PAPER SIZE:	A3	DATE:	Sep 2019
DWG No.	4562-01-	108	REV.



Bracewell Stirling CONSULTING

38 WALKER TERRACE, TILLICOULTRY, FK13 6EF 5 NESS BANK, INVERNESS, IV2 4SF 15 LOCHSIDE STREET, OBAN, PA34 4HP

01259 750301 01463 233760 01631 359054

__LGFL

01) Stone basecourse

(02) Render finish

03) uPVC windows

(05) Concrete slip cills

(06) Concrete tiles

(07) Timber cladding

All colours as External

Galvanised steel gutters & downpipes

NEW HOUSING, DUNBARRY TERRACE KINGUSSIE

DAVALL DEVELOPMENTS LTD

HOUSE TYPE F (4BV 234) - ELEVATIONS

 SCALE:
 1:100
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 PL

 PAPER SIZE:
 A3
 DATE:
 Sep 2019

 DWG No.
 4562-01-111
 REV.


IMAGE 1 - FRONT PERSPECTIVE

REAR ELEVATION

REV DATE DESCRIPTION


SIDE ELEVATION

IMAGE 2 - REAR PERSPECTIVE 1:100

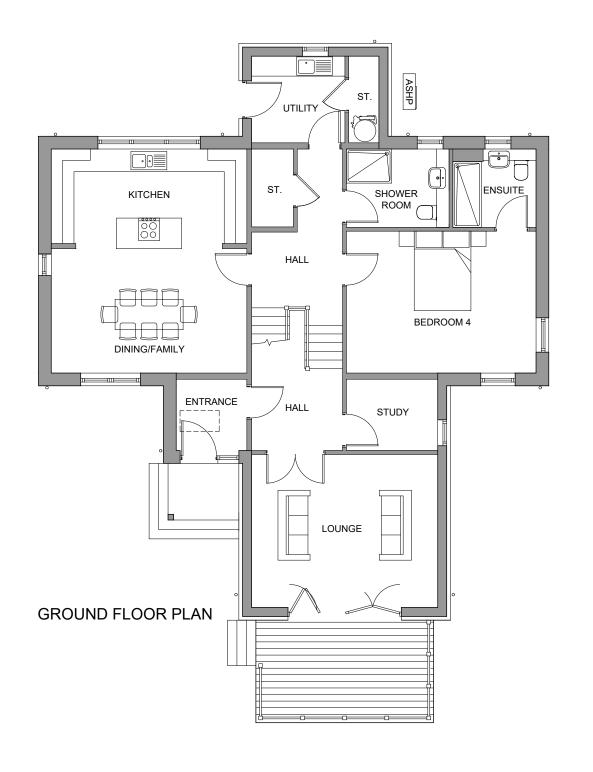



1:200 0

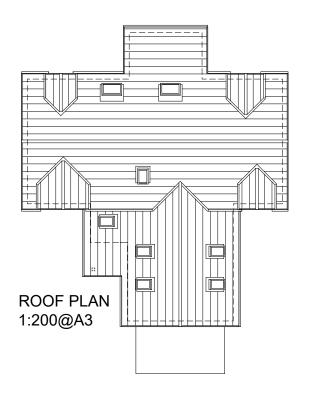

REV DATE DESCRIPTION

Bracewell Stirling CONSULTING

38 WALKER TERRACE, TILLICOULTRY, FK13 6EF 5 NESS BANK, INVERNESS, IV2 4SF 15 LOCHSIDE STREET, OBAN, PA34 4HP

01463 233760 01631 359054


NEW HOUSING, DUNBARRY TERRACE KINGUSSIE

DAVALL DEVELOPMENTS LTD


HOUSE TYPE F (4BV 234) - PLANS

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1:100 0 1m 2m 3m	6m	PAPER SIZE:	A3	DATE:	Sep 2019
		DWG No.	4562-01-	110	REV.


12m

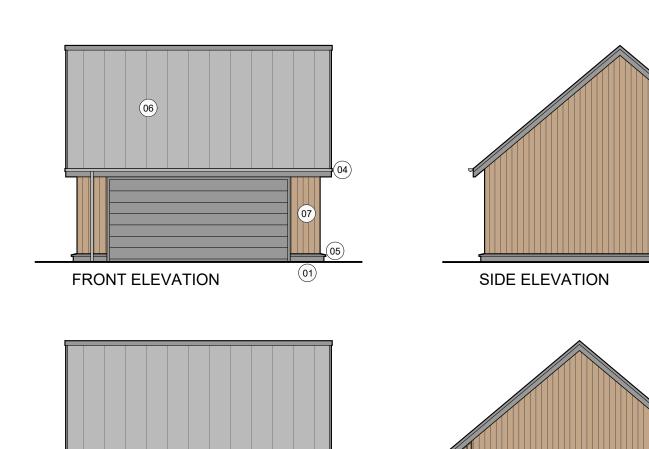

SIDE ELEVATION

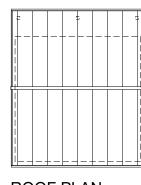

ROOF PLAN 1:200@A3

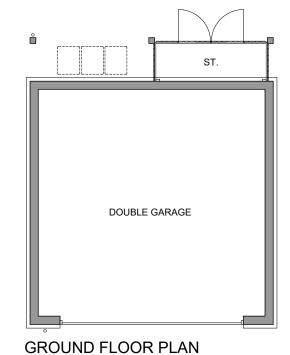

- O1) Smooth render basecourse
- Galvanised steel gutters & downpipes
- 05 Concrete cills
- 06 Metal roof covering
- (07) Timber cladding

All colours as External Finishes Schedule

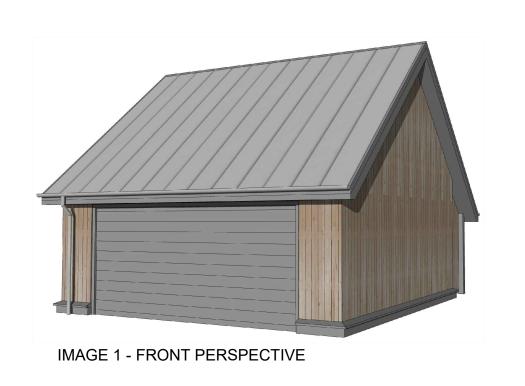




IMAGE 2 - REAR PERSPECTIVE

Bracewell Stirling CONSULTING

38 WALKER TERRACE, TILLICOULTRY, FK13 6EF 5 NESS BANK, INVERNESS, IV2 4SF 15 LOCHSIDE STREET, OBAN, PA34 4HP


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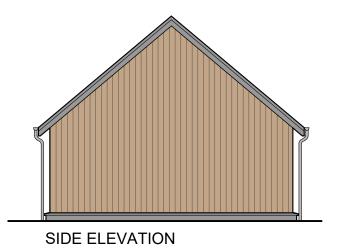
NEW HOUSING, DUNBARRY TERRACE KINGUSSIE


DAVALL DEVELOPMENTS LTD

DOUBLE GARAGE - TYPE 1 - PLANS AND ELEVATIONS


DWG No.	4562-01-	112	REV.
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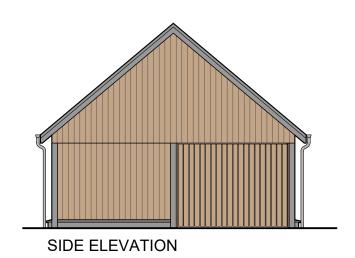





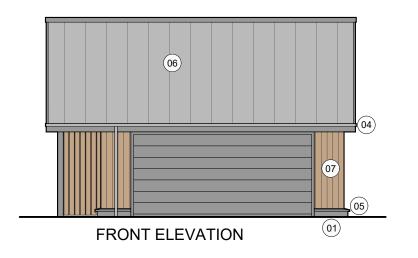

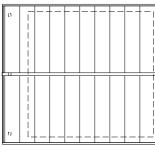ROOF PLAN 1:200@A3



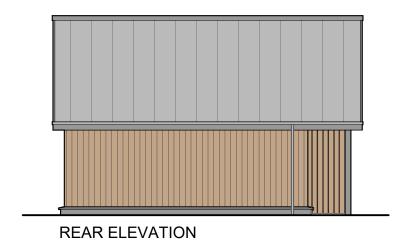

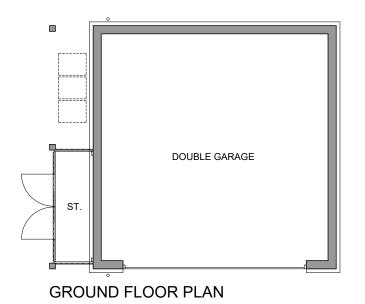

- O1) Smooth render
- Galvanised steel gutters & downpipes
- 05 Concrete cills
- 06 Metal roof covering
- 07 Timber cladding

All colours as External Finishes Schedule

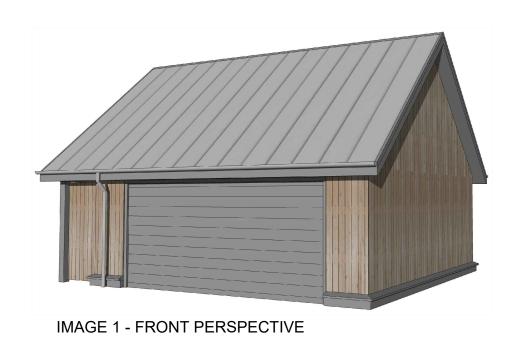




IMAGE 2 - REAR PERSPECTIVE

1:200 0 2	m 4m 6m	12m
1:100 0 1	m 2m 3m	6m
		-
REV DATE DESCRIP	TION	DRN

Bracewell Stirling CONSULTING

38 WALKER TERRACE, TILLICOULTRY, FK13 6EF 5 NESS BANK, INVERNESS, IV2 4SF 15 LOCHSIDE STREET, OBAN, PA34 4HP

01259 750301 01463 233760 01631 359054

NEW HOUSING, DUNBARRY TERRACE KINGUSSIE

DAVALL DEVELOPMENTS LTD

DOUBLE GARAGE - TYPE 2 - PLANS AND ELEVATIONS

PAPER SIZE:	^{A3} 4562-01-	DATE:	Sep 2019 REV.
SCALE:	1 : 100	DRAWN:	PL



KEY

Existing Scots pine woodland to site boundaries.

Existing trees - Refer to Pals Tree Survey Report and Tree Constraints Information for full details of retained trees and trees to be felled. (June 2020)

Proposed Woodland screening planting including mesh tree shelters @ 3m centres. Trees-Birch, Aspen, Oak and Rowan. Shrubs- Hazel, Holly, Juniper species.

Proposed in-curtilage tree and shrub planting including mesh tree/ shrub shelters @ 3-4m centres. Birch, Rowan, Oak, Hazel and Holly species.

Proposed 2.5-3m tall, standard tree planting- Birch and Rowan and Cherry species.

Proposed 1.5-1.75m tall, feathered tree planting to open spaces: Alder, Birch, Rowan, Cherry and Aspen species.

Proposed mixed species hedge planting: Open space Area B: Hazel, Hawthorn and Holly species.

Proposed mixed species hedge planting: Areas A, C and

D: Beech, Hawthorn and Rose species.

Proposed native shrub planting mix; Heather, Hazel, Broom, Holly and Juniper species shrubs.

Proposed open spaces: top-soiled, cultivated, stone picked and grass seeded. (Close mown grass areas.) Proposed open spaces: top-soiled, cultivated, stone picked and seeded with a grass / wildflower seed mix. (Scotia seeds: 'Highland Grassland Mix' to create species rich long grass areas- annual cut back.)

Proposed Suds swale drains: top-soiled, cultivated, ston-picked and seeded with a grass / wildflower seed mix. Proposed Suds swale drains: top-soiled, cultivated, stone (Scotia seeds: 'Highland Grassland Mix' to create species rich long grass areas- annual cut back.)

Proposed gardens: top-soiled, cultivated, stone picked and turfed or seeded.

> EXISTING TREES NOTES For full details of the existing trees on the site and boundaries refer to PALS Tree Survey - June 2020

- A: 02.07.20 Landscape proposals amended to show the existing tree locations and proposed tree protection fencing and to suit the client's comments. KW B: 07.07.20 Landscape proposals revised to Bracewell
- Stirling comments as requested.KW : 23.07.20 Landscape proposals revised to BS drawing 4562-02-003F (Plots 16-19 amended). Treplanting and grass areas adjusted to suit.KW 2: 30.10.20 Landscape plans revised to scope of BS

site layout plan 4562-02-003G and CNPA's landscape consultant's comments. Plots 1-5

- relocated, road alignment at plot 23revised, widening of swale corridors, Swale corridors seeding / management altered to create species rich long grass areas. Additional in-curtilage screening planting added to plots 20-22. Western in northern dry stone walling repairs. Oak trees to northern boundary confirmed as Category B- to be protected with tree protection fencing as per
- PALS's recommendations.KW 02.11.20 Landscape proposals updated at plot 23, hedgeline amended. Home Owners Maintenance and Management Guide prepared.KW 10.02.21 Landscape proposals revised to new site layout (4562-02-003 Rev L. Tree planting, hedging and grassed areas revised to suit new layout / plot arrangements. Planting schedule and maintenance schedules updated.KW

LANDSCAPE DESIGN


1,Old Branziet Cottage, Balmore, By Torrance, Glasgow, G64 4AH. Tel: 01360 620358 Mob:07584 054586 email: keith.l.wood@btopenworld.com www.keithlwoodlandscapedesign.scot

Project Title: NEW HOUSING, DUNBARRY TERRACE, KINGUSSIE. CLIENT: DAVALL DEVELOPMENTS DRAWING LANDSCAPE PROPOSALS
TITLE: (Plots 1.14)


(Plots 1-14)

PLANNING

Scale 1:250@ A0 Date 30.06.20 Drawn k wood Drawing No. DD DT 100.20 SL-01 Rev. F

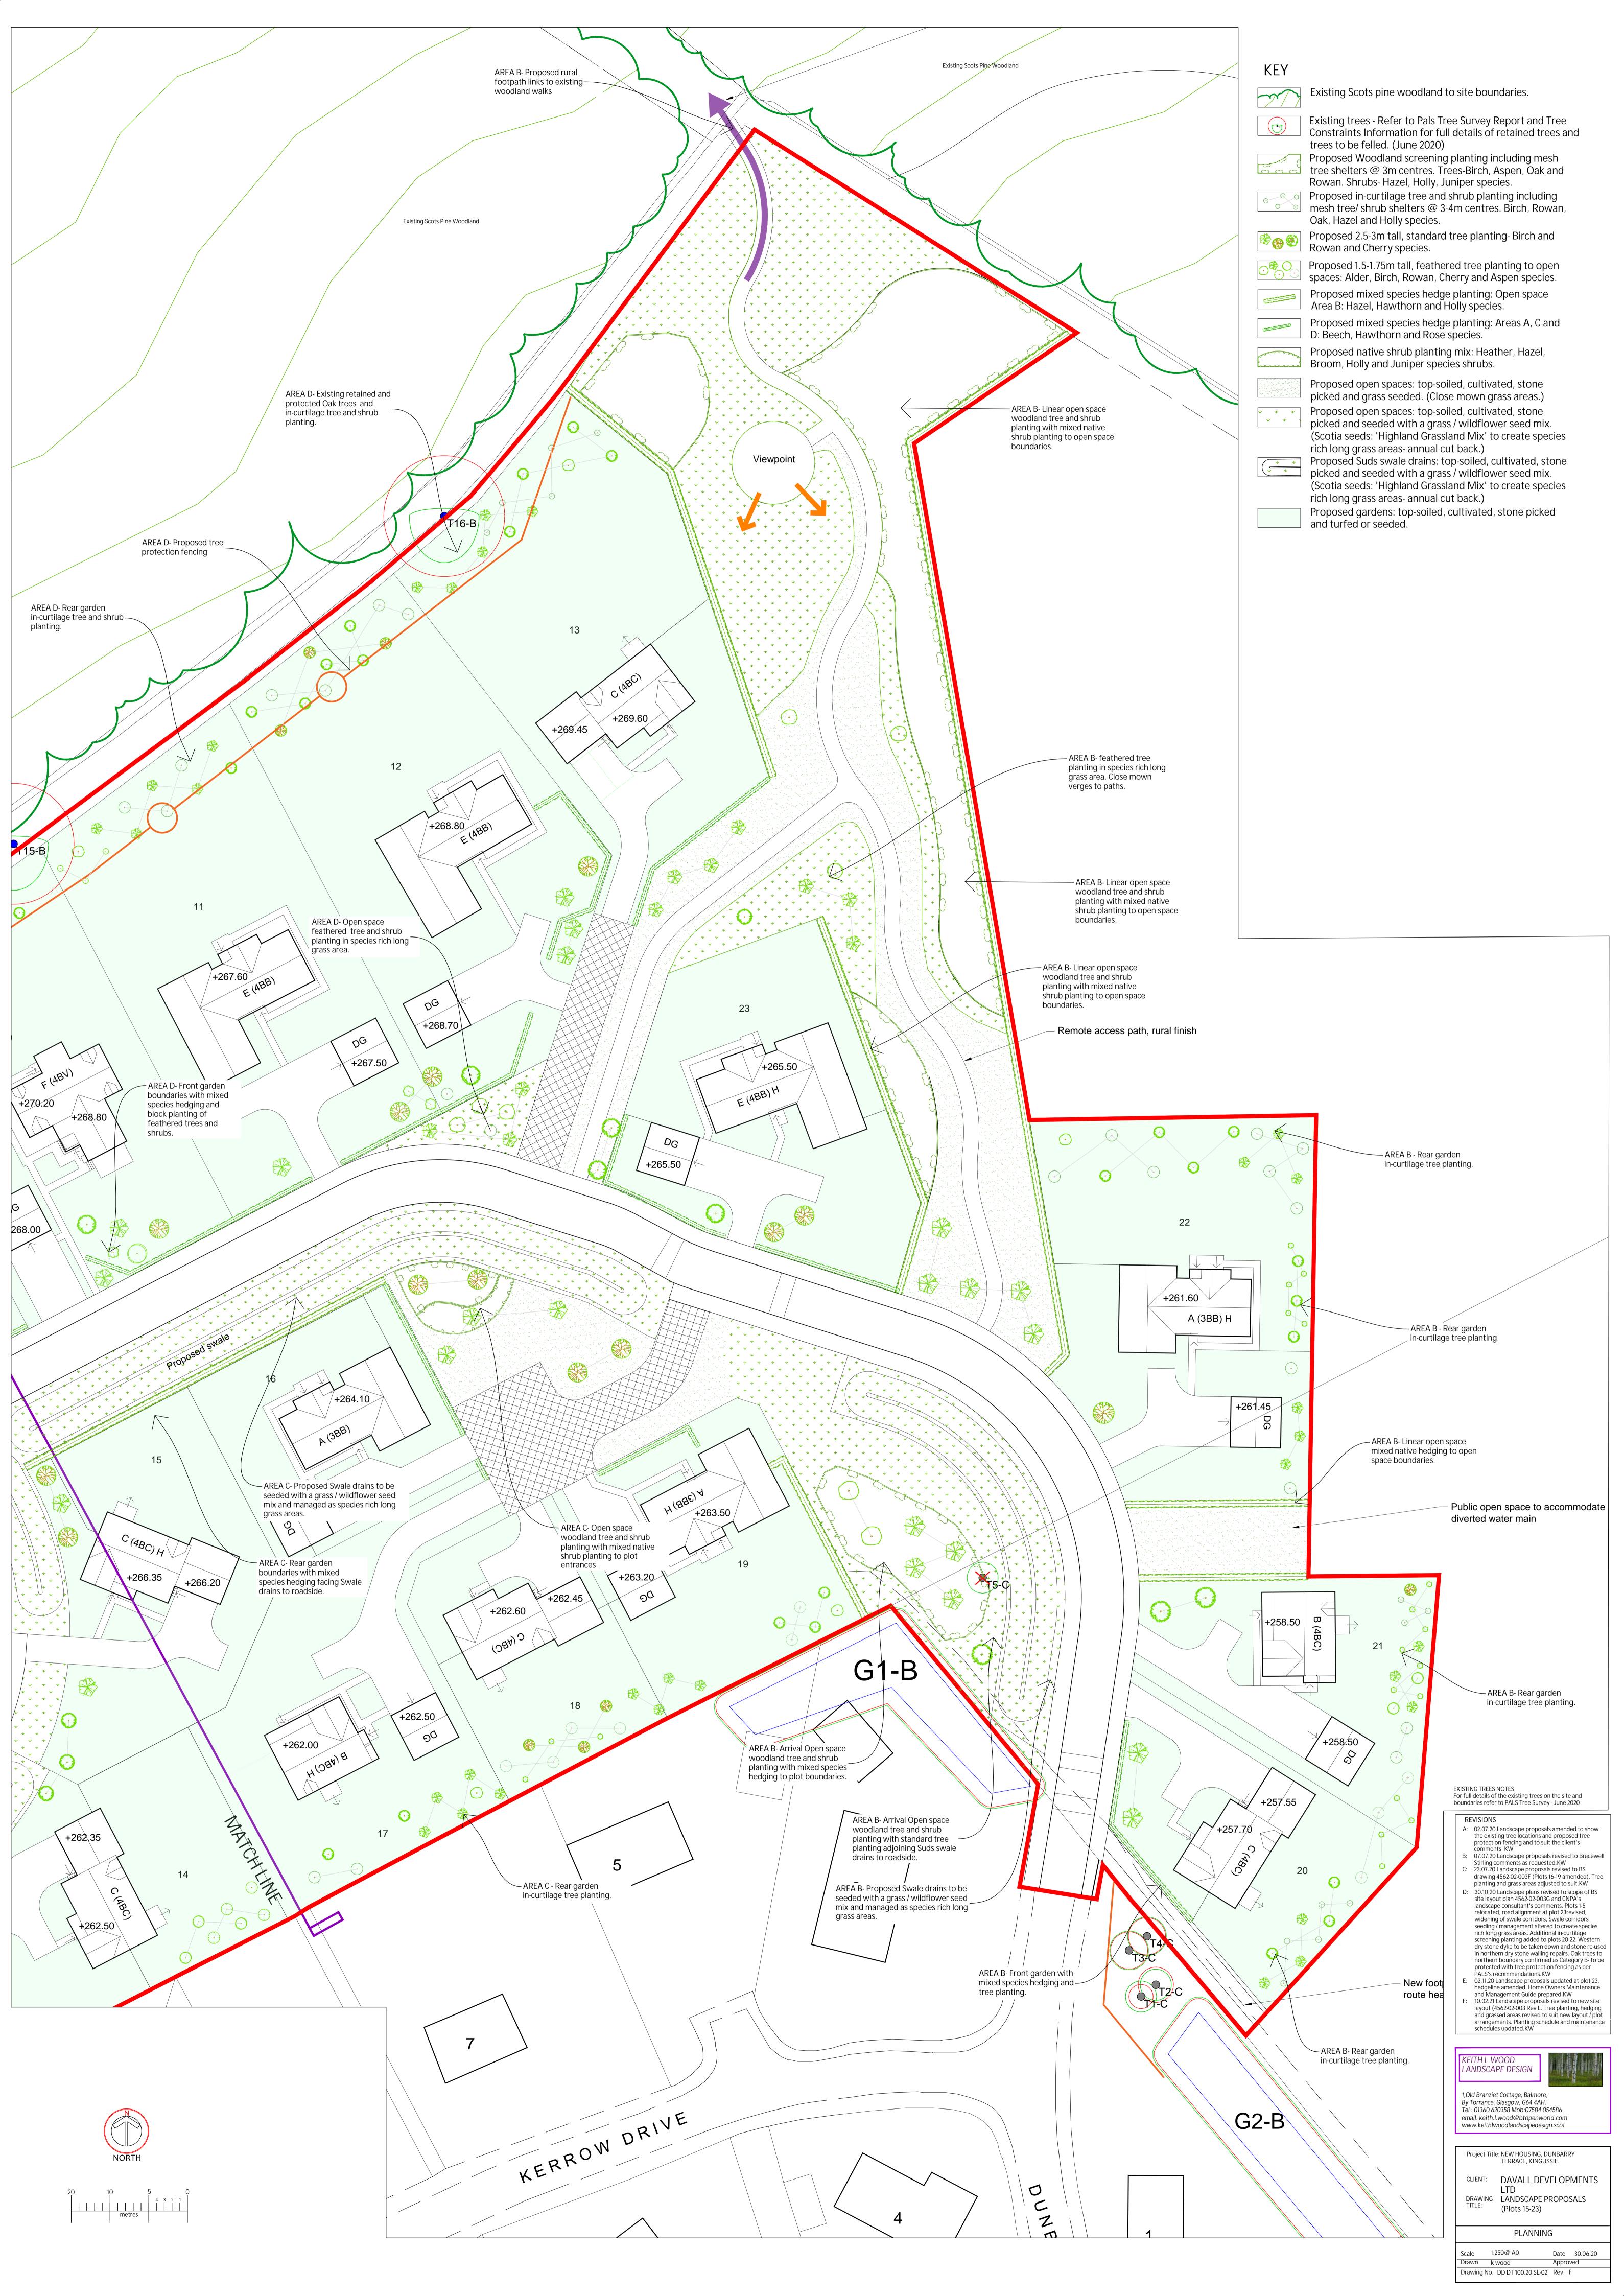



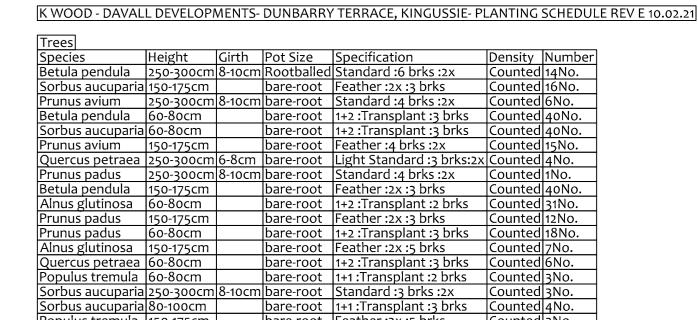

|Height |Pot Size |Specification |60-80cm |bare-root|1+1: Transplant: 3 brks |5/m

Species	Height	Pot Size	Specification	Density	Percentage Contribution	Number
Corylus avellana	60-80cm	bare-root	1+1: Transplant: 3 brks	5/m	10%	232No.
Crataegus monogyna	60-80cm	bare-root	1+1: Transplant: 3 brks	5/m	65%	1485No.
Ilex aquifolium	30-40cm	9cm	Bushy hedging	5/m	25%	574No.
						Total:2291No

Species	Height	Pot Size	Specification	Density	Percentage Contribution	Numb
Calluna vulgaris	20-25cm	9cm	Bushy	2/m²	15%	13No.
Corylus avellana	60-80cm	bare-root	1+1:Transplant: 3brks	2/m²	25%	21No.
Cytisus scoparius	30-40cm	9cm	Bushy	2/m²	5%	5No.
Ilex aquifolium	30-40cm	9cm	Bushy	2/m²	20%	17No.
Juniperus communis	10-20cm	2L	Bushy	2/m²	35%	29No.

WOODLAND SCREEN	MING MILV					
Species	Height	Pot Size	Specification	Density	Percentage Contribution	Number
Betula pendula	80-100cm	bare-root	1+1:Transplant:3 brks	3Ctr	30%	72No.
Corylus avellana	60-80cm	bare-root	1+1 :Transplant: 3brks	3Ctr	10%	27No.
Ilex aquifolium	30-40cm	9cm	Bushy	3Ctr	5%	16No.
Juniperus communis	30-40cm	2L	Bushy	3Ctr	5%	16No.
Populus tremula	80-100cm	bare-root	1+1:Transplant:2 brks	3Ctr	10%	27No.
Quercus petraea	80-100cm	bare-root	1 u1:Transplant:3 brks	3Ctr	10%	27No.
Sorbus aucuparia	80-100cm	bare-root	1+1:Transplant:3 brks	3Ctr	30%	72 No.

All areas to be soft landscaped to be litter picked and all site debris / stones etc to be removed from site. All subsoil to be thoroughly de-compacted following completion of building works and removal of scaffolding, to ensure that they are free

Samples of existing stored topsoil to be tested and results passed to project Landscape Architect for confirmation / approval. Proposed Shrub beds: Shrub planted areas to be formed with a minimum 300mm depth of premium quality topsoil laid on a clean de-compacted subsoil layer. Supply and spread a 35mm deep layer of PAS 100 soil improver and work into soil during planting. Shrub planted areas to be enclosed with a temporary low rabbit mesh fence -set 600mm above ground level with base dug into

ground and turned out from shrub bed: (1050 x 31 x 19 gauge, galvanised netting) secured with U fencing staples, galvanised to 32mm square posts driven into ground. Hedging trenches: Hedging to be pit planted into prepared topsoiled trench, 450 x 450 x 300mm deep backfilled with salvaged topsoil mixed with a 35mm deep layer of PAS 100 soil improver, worked into hedging trench during planting. Hedging transplants to be protected with a clear spiral guards (60cm x 38mm dia) with a single bamboo cane.

Tree Planting: Standard trees to be pit planted into 900 x 900 x 600mm deep pits with base broken up for a further 150mm. Pits to be backfilled with premium quality topsoil mixed with 35mm deep layer of PAS 100 soil improver worked into tree pit backfill material. Feathered trees pit planted as above in 600 x 600 x 450mm deep pits. Tree roots to be treated with Rootgrow

Tree Ties and Stakes: Standard and feathered trees to be single stakes with 50mm diameter machine rounded stakes, driven into base of pit and finished 500m above ground level. Trees secured to stake with Holdfast HB2 rubber spacer block and Holdfast HR40 rubber belting, nailed to stakes with galvanised clout nails. Any failures in planting in the first five years after planting will be replaced by the client with plants of an equal size / specification

as to the planted species (in the next planting season.) Grass Areas: Areas to be grassed are to be topsoiled with site salvaged soil, minimum 150mm deep spread over the de-compacted

Close mown grassed areas to be weed-killed, cultivated, stone picked to remove any stones over 35mm and sown with Blec 2 pass technique using the following seed mix@ 40g/m2

Anthoxanthum oderatum (Sweet vernal grass) 20% Deschampsia flexuosa (Wavy Hair Grass) 30%

Festuca ovina (Sheeps fescue) 25%

Poa pratensis (Smooth stalked Meadow Grass) 15% Apply a pre-seeding fertiliser (6-9-6 mix) @ 70g/m2* Mix to be confirmed by Landscape Architect following receipt of topsoil test

Proposed species rich long grass areas: subsoil to be de-compacted and 150mm minimum depth of site salvaged topsoil spread Proposed long grass areas to be weed-killed twice (allowing for sufficient time to elapse between applications- as directed by herbicide manufacture's guidelines) prior to cultivation and sowing with the following mix:

Scotia seeds 'Highland Grassland Mix' or equivalent (17 wildflower species and 10 grass and rush species) sown at 3g/m2 Turfed areas to be de-compacted and a minimum of 150mm site salvaged topsoil spread over subsoil. Areas to be weed-killed, cultivated and stone picked to remove any stones over 35mm size and turfed with Scotlawn 'Silver Grade' or equivalent premium

Refer to the Maintenance schedule for details of the proposed communal areas maintenance regime, including establishment cuts for the proposed species rich long grass areas for the site to be undertaken intially for the first five years after planting and

then in perpetuity by a Factor on behalf of the client.

site and boundaries refer to PALS Tree Survey - June 2020. PLANTING PLAN PLOTS 15-23 Refer to drawing DD DT 100.20 SL-04E for full details of proposed planting for plot 15-23. LANDSCAPE MAINTENANCE

EXISTING TREES For full details of the existing trees on the

Refer to Landscape Maintenance schedule for details of proposed establishment maintenance for the communal

A: 07.07.20 Planting Plans revised to Bracewell

23.07.20 Planting plans revised to latest site plan BS 4562-02-003 F. Planting / seeding adjusted at

: 30.10.20 Planting plans revised to scope of BS site layout plan 4562-02-003G and CNPA's landscape

alignment at plot 23revised, widening of swale

altered to create species rich long grass areas.

Additional in-curtilage screening planting added to

plots 20-22. Western dry stone dyke to be taken

walling repairs. Oak trees to northern boundary

02.11.20 Landscape proposals updated at plot 23,

and Management Guide prepared.KW

and maintenance schedule updated.KW

hedgeline amended. Home Owners Maintenance

10.02.21 Landscape proposals updated to scope of

revised site plan 4562-02-003 L. Planting schedule

confirmed as Category B- to be protected with tree

down and stone re-used in northern dry stone

protection fencing as per PALS's

recommendations.KW

corridors, Swale corridors seeding / management

Stirling comments as requested.KW

Existing Scots pine woodland to site boundaries.

Existing trees - Refer to Pals Tree Survey Report and Tree Constraints Information for full details of retained trees and trees to be felled. (June 2020)

Rowan. Shrubs- Hazel, Holly, Juniper species. Proposed in-curtilage tree and shrub planting including mesh tree/ shrub shelters @ 3-4m centres. Birch, Rowan,

Oak, Hazel and Holly species. Proposed 2.5-3m tall, standard tree planting- Birch and

Proposed 1.5-1.75m tall, feathered tree planting to open spaces: Alder, Birch, Rowan, Cherry and Aspen species. Proposed mixed species hedge planting: Open space

Proposed mixed species hedge planting: Areas A, C and D: Beech, Hawthorn and Rose species. Proposed native shrub planting mix; Heather, Hazel,

Broom, Holly and Juniper species shrubs. Proposed open spaces: top-soiled, cultivated, stone picked and grass seeded. (Close mown grass areas.)

picked and seeded with a grass / wildflower seed mix. (Scotia seeds: 'Highland Grassland Mix' to create species rich long grass areas- annual cut back.) Proposed Suds swale drains: top-soiled, cultivated, stone picked and seeded with a grass / wildflower seed mix. rich long grass areas- annual cut back.)

(Scotia seeds: 'Highland Grassland Mix' to create species Proposed gardens: top-soiled, cultivated, stone picked

KEITH L WOOD LANDSCAPE DESIGN 1,Old Branziet Cottage, Balmore, By Torrance, Glasgow, G64 4AH. Tel: 01360 620358 Mob:07584 054586 email: keith.l.wood@btopenworld.com www.keithlwoodlandscapedesign.scot

Project Title: NEW HOUSING, DUNBARRY TERRACE, KINGUSSIE. CLIENT: DAVALL DEVELOPMENTS

LTD

DRAWING LANDSCAPE PROPOSALS PLANTING PLAN (Plots 1-14) PLANNING

Scale 1:250@ A0 Date 02.07.20 Drawn k wood Approved Drawing No. DD DT 100.20 SL-03 Rev. E

